

# ROCKFORD BOARD OF EDUCATION INVITATION FOR BID ON SUPPLIES, MATERIALS, EQUIPMENT OR SERVICES FOR SCHOOL DISTRICT NO. 205 ROCKFORD, ILLINOIS

IFB No. 19-13 Asbestos Abatement Project at Froberg and Hillman Schools

DATE: January 4, 2019

RE: **ADDENDUM NO. 1** 

### To All Bidders:

Included are modifications, clarifications and/or corrections for the Project Manual and are hereby made a part of the contract documents. Please attach this addendum to the Project Manual(s) in your possession. Please note the receipt of this addendum on the bid form. Bidders shall review changes to all portions of this work as changes to one portion may affect the work of another.

If you plan to hand deliver your IFB submission on the due date, please note you must check in on the 2nd floor prior to coming to the bid opening. Please allow time for this as late submission will not be accepted.

Refer all questions relative to the business aspect, Instructions to Bidders, Special Conditions, and questions concerning the technical aspect of the documents to the Director of Purchasing by email at <a href="mailto:purchasingdeptstaff@rps205.com">purchasingdeptstaff@rps205.com</a>.

### ROCKFORD BOARD OF EDUCATION

By: Dane Youngblood Director of Purchasing

Carnow, Conibear & Assoc., Ltd. Environmental Consulting Services 600 W. Van Buren St., Suite 500, Chicago, IL 60607 t: 312.782.4486 f: 312.782.5145 www.ccaltd.com



DATE: January 3, 2019

TO:

Guy Carynski Dane Youngblood Casey Ramas Tim Holian Guido Gorniak Tomasz Stogowski

Tim Boll

**Kevin Montgomery** John Curtis

Evan Christian Rod Harvey

guy.carvnski@rps205.com dane.youngblood@rps205.com

ramasc@rps205.com tim@holianins.com

quido@abelplusservices.com tomasz.husar1@gmail.com

tboll@colfaxcorp.net

kevinvalortechnologies@gmail.com

john.curtis@brockgroup.com echristian@ccaltd.com rharvey@ccaltd.com

SUBJECT: ADDENDUM NO. 1 TO THE BIDDING DOCUMENTS

> PROJECT MANUALS Rockford Public Schools District #205 – Hillman Elementary School and White Swan Elementary School – Window Replacement Asbestos Abatement dated December 7, 2018

This addendum forms a part to the bidding and contract documents and modifies the original bidding documents, dated December 7, 2018. ALL CONTRACTORS SHALL ACKNOWLEDGE WRITTEN RECEIPT OF THIS ADDENDUM ON THEIR BID FORM. FAILURE TO DO SO MAY SUBJECT BIDDER TO DISQUALIFICATION. This addendum consists of one (1) page and five (5) asbestos abatement design drawings. Additionally, architectural drawings are included for reference.

### Addendum #1

- 1. Froberg Elementary School Additions to Scope of Work Drawings ASB-0 and ASB-1.
- 2. Hillman Elementary School Additions to Scope of Work Drawings ASB-0, ASB-1,

Except as modified herein, Addendum No. 1, Project Manual dated December 7, 2018 remain in full force and effect.

Sincerely,

CARNOW, CONIBEAR & ASSOC., LTD.

Rod Harvey, P.E., CIH, CSP Director, Client Services

### **Froberg Elementary School**

4555 20th Streeet

Rockford, Illinois 61109

### ASBESTOS ABATEMENT SCOPE OF WORK:

- 1. Base Bid Item 1: Exterior removal and disposal of existing window assemblies including the frames, and all asbestos-containing interior and exterior perimeter caulk, glazing compounds and putty as detailed in the environmental scope of work drawing ASB-1.
  - Remove and salvage existing window air conditioner units for reinstallation by window
  - Remove and salvage existing window treatment for reinstallation by window contractor
- 2. <u>Base Bid Item 2:</u> Exterior removal and disposal of existing door, frames, associated hardware, and all ACM caulking and sealants window assemblies including the frames, and all asbestos-containing interior and exterior perimeter caulk, glazing compounds and putty as detailed in the environmental scope of work drawing ASB-1.
- Alternate Bid Item 1: Removal and disposal of existing door, frames, associated hardware, and all NON-ACM caulking and sealants as detailed in the environmental scope of work drawing ASB-1.

### GENERAL CONSTRUCTION / DEMOLITION NOTES:

- 1. The Abatement Contractor is responsible for verifying quantities in the field before pricing. Any questions about the scope or clarifications shall be obtained from the Project Designer prior to bidding. Any interpretations of the design documents shall only be made by the Project Designer.
- Abatement contractor shall perform any interior abatement in such a manner that interior spaces are protected from dust and debris. Abatement contractor will clean all affected interior spaces to pre-demolition conditions.
- Locations for the staging of aerial lifts, materials and dumpsters shall be coordinated with RPS205 prior to mobilization.
- Removal and relocation of building contents necessary to accommodate work shall be the responsibility of RPS 205.
- RPS 205 will provide electrician for connection/disconnections of any electrical necessary to support abatement. Abatement Contractor shall supply all parts and equipment.
- Coordination with the electrician shall be made at least 48 hours prior to mobilization or demobilization.

### **GENERAL ABATEMENT NOTES:**

- All asbestos abatement shall be in accordance with specification Section 02132 (exterior asbestos abatement).
- The Abatement Contractor shall coordinate the abatement schedule with General Contractor, RPS 205, and Carnow Conibear.
- The Abatement Contractor Representative is responsible for attendance at any preconstruction and or coordination meetings prior to mobilization and during all abatement activities.
- Caution signs shall be posted adherent to specification requirements of OSHA 29 CFR 1926.1101(k)(6) at all potential entrances or barriers to the regulated abatement areas.
- Abatement contractor responsible for daily cleanup and disposal of debris generated during abatement activities.

### **EXTERIOR ABATEMENT NOTES:**

- The Abatement Contractor is expected to complete up to 8 windows per work shift.
- Abatement of windows shall be conducted from the building exterior only. Interior building areas shall be sealed air tight with 6-mil poly and as necessary, rigid sheeting and framing at each window opening. At no time shall abatement activities be conducted from the building interior.
- General Contractor responsible for the removal and disposal of all interior window treatments and associated backing/supports.
- Abatement Contractor responsible for the removal and disposal of all existing screens.
- Abatement Contractor responsible for any interior damage exceeding 1" from window framing.
- Abatement Contractor shall document existing conditions of and is responsible for the protection of any exterior landscaping, turf, concrete sidewalks, or interior furnishings from

- damage. Repair or replacement of surfaces damaged during the abatement process shall be the responsibility of the Abatement Contractor.
- Abatement Contractor responsible for the temporary removal and set aside of any existing window air conditioners and associated supports and brackets. Removed A/C units and hardware shall be set on plywood sheeting within the room from where it was removed. Abatement Contractor is NOT responsible for reinstallation of the removed A/C units.
- The Abatement Contractor is responsible for all demolition associated with the existing window systems. Following the abatement/demolition of the existing window system, the window opening shall be free of any clips, masonry, mortar drips, wood blocking / framing, etc that may interfere with the new window installation.
- Interior plastic sheeting installed for abatement purposes shall be removed and disposed as abatement waste by the Abatement Contractor immediately following abatement activities.

#### WINDOW / DOOR BOARD-UP NOTES:

- When windows or doors are removed for abatement purposes. Abatement Contractor responsible for the board-up of buillding opening prior to abatement. Board-up requirements include, at a minimum, 2"x4" framing and 1/2" plywood sheathing. Board-up shall include 1 layer of 6mil poly sheeting on the exterior side of the board-up when necessary for protection from rain/water.
- 2. Abatement Contractor responsible for the maintenance of board-up until removal by the Window Contractor.
- The Abatement Contractor is expected to maintain board-up of up to 45 windows during the overall window replacement schedule.
- Window Contractor responsible for removal of the board-up and to set aside board up materials for reuse by the Abatement Contractor.

#### SCHEDULE:

- The work is scheduled for RPS205 Summer Break 2019, as follows:
- 2. NOTE: The exact start and stop dates may be modified for coordination purposes, however time frames to complete each abatement area shall not be exceeded.

	DRAWING HISTORY											
NO.	DATE	DRAWN BY:	CHECKED BY:	REMARKS								
1	12/07/18	J. Kalingasan	E. Christian									
2	12/31/18	A. Rodriguez	E. Christian	Addendum #1								
0												

**Rockford Public Schools** 501 7th Street Rockford, Illinois 61104

PROJECT NAME **Asbestos Abatement Froberg Elementary School** 4555 20th Street Rockford, Illinois 61109

Rod Harvey

IDPH #: 100-01548

PROJECT DESIGNER

SHEET TITLE:

DESIGNER SIGNATUR

**GENERAL NOTES** 

ADDENDUM #1


600 W. Van Buren St., Suite 500, Chicago, IL 60607 t: 312.782.4486 f: 312.782.5145

Carnow. Conibear & Assoc., Ltd.

December 31, 2018 ASB-0

CA PROJECT NO

CARNOW CONIBEAR

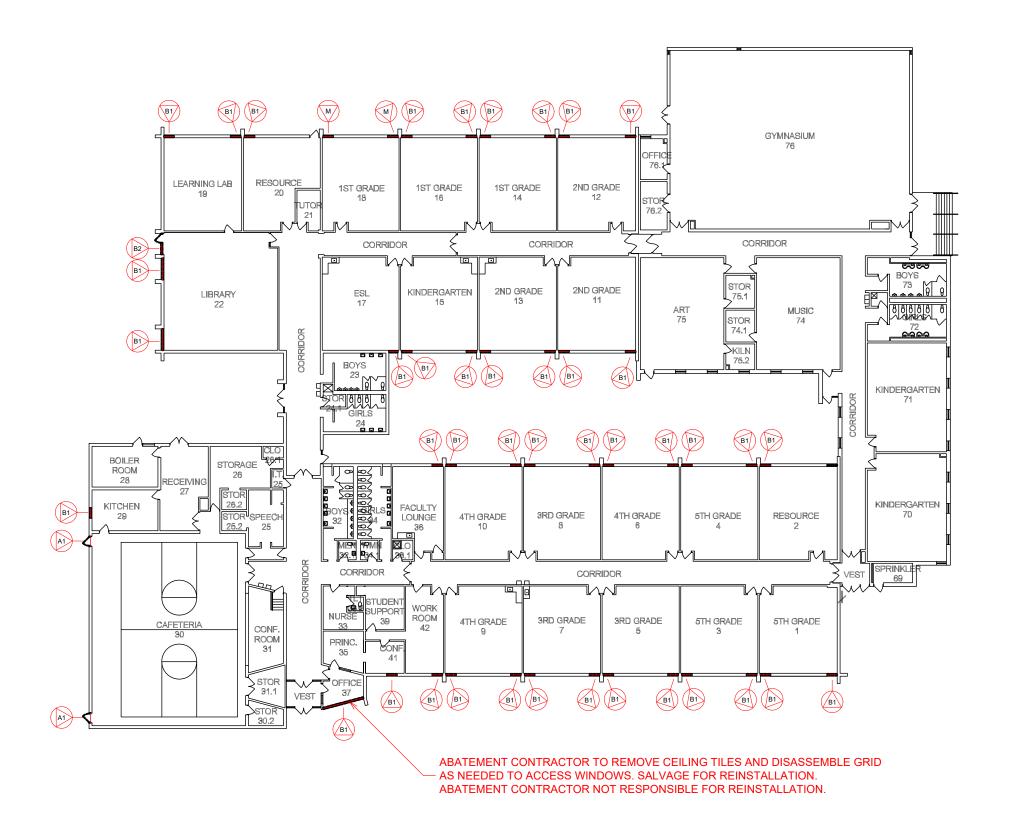

### SCOPE OF WORK:

- 1. Base Bid item 1: Exterior removal and disposal of existing window assemblies including including the frames, and all asbestos-containing (ACM) interior and exterior perimeter caulk, glazing compounds, putty and construction mastics. Interior window sills to remain.
- 2. Base Bid Item 2: Removal and disposal of existing door, frames, associated hardware, and all ACM caulking and
- 3. Alternate Bid Item 1: Removal and disposal of existing door, frames, associated hardware, and all NON-ACM caulking and
- 4. All work per specification number 02132 and all applicable IDPH, IEPA and OSHA regulations.
- 5. Abatement Contractor to remove up to 8 single windows or 12 banked windows per day. The specific sequencing of the work to be determined and coordinated with the Owner and the General Contractor.
- 6. Refer to architectural drawings for window and door assembly details.

### WINDOW DEMOLITION / EXTERIOR APPROXIMATE ASBESTOS ABATEMENT **WORK SCHEDULE:**

TAG	START DATE	END DATE	WORK SEQUENCE
M	2/15/2019	2/15/2019	Base Bid Work - Exterior Asbestos Abatement / Window Demolition Mock-up Location
B1	6/10/2019	7/19/19	Base Bid Work, Item 1 - Exterior Asbestos Abatement / Window Demolition
B2	6/10/2019	7/19/19	Base Bid Work, Item 2 - Exterior Asbestos Abatement / Door Demolition
(A1)	6/10/2019	7/19/19	Alternate Item 1 - Exterior Door Demolition (NON-ACM)

FIRST FLOOR	
EXTERIOR ASBESTOS ABATEMENT	1/32" = 1'

PROJECT DESIGNER

DRAWING HISTORY										
NO.	DATE	DRAWN BY:	CHECKED BY:	REMARKS						
1	12/07/18	J. Kalingasan	E. Christian							
2	12/31/18	A. Rodriguez	E. Christian	Addendum #1						
0										

**Rockford Public Schools** 501 7th Street Rockford, Illinois 61104

**Asbestos Abatement Froberg Elementary School** 4555 20th Street Rockford, Illinois 61109

> Rod Harvey IDPH #: 100-01548

**EXTERIOR ASBESTOS ABATEMENT FIRST FLOOR** ADDENDUM #1

Carnow. Conibear & Assoc., Ltd. 600 W. Van Buren St., Suite 500, Chicago, IL 60607 t: 312.782.4486 f: 312.782.5145 December 31, 2018

ASB-1

**CARNOW CONIBEAR** 

### Hillman Elementary School

3701 Green Dale Drive

Rockford, Illinois 61109

### ASBESTOS ABATEMENT SCOPE OF WORK:

- 1. <u>Base Bid Item 1:</u> Exterior removal and disposal of existing window assemblies including the frames, and all asbestos-containing interior and exterior perimeter caulk, glazing compounds and putty as detailed in the environmental scope of work drawings ASB-1 through ASB-2.
  - a. Remove and salvage existing window air conditioner units for reinstallation by Window Contractor
  - Remove and salvage existing interior window treatments in rooms noted in architectural drawings.
- 2. <u>Base Bid Item 2:</u> Removal and disposal of existing window assemblies, including the frames and all NON-ACM interior and exterior perimeter caulk, glazing compounds, putty, and Construction mastics
- 3. <u>Alternate Bid Item 1</u>: Removal and disposal of existing door, frames, associated hardware, and all NON-ACM caulking and sealants. Removal and disposal of approximately five (5) square feet of Asbestos-Containing flooring (All Layers) at the interior of each door opening.

#### GENERAL CONSTRUCTION / DEMOLITION NOTES:

- The Abatement Contractor is responsible for verifying quantities in the field before pricing.
   Any questions about the scope or clarifications shall be obtained from the Project Designer prior to bidding. Any interpretations of the design documents shall only be made by the Project Designer.
- Abatement contractor shall perform any interior abatement in such a manner that interior spaces are protected from dust and debris. Abatement contractor will clean all affected interior spaces to pre-demolition conditions.
- Locations for the staging of aerial lifts, materials and dumpsters shall be coordinated with RPS205 prior to mobilization.
- 4. Removal and relocation of building contents necessary to accommodate work shall be the responsibility of RPS 205.
- 5. RPS 205 will provide electrician for connection/disconnections of any electrical necessary to support abatement. Abatement Contractor shall supply all parts and equipment.
- 6. Coordination with the electrician shall be made at least 48 hours prior to mobilization or demobilization.

### **GENERAL ABATEMENT NOTES:**

- 1. All asbestos abatement shall be in accordance with specification sections 02131 (interior asbestos abatement) or Section 02132 (exterior asbestos abatement).
- 2. Flooring Abatement If gross removal methods are utilized, Contractor shall perform all work in strict accordance with all IDPH school rules and specification 02131. If non-friable removal methods are utilized (Specification Section 3.11(D)), Contractor shall be responsible for the isolation of the work area(s) with critical seals, warning signs, and the security of the work areas to eliminate access by unauthorized personnel. HEPA filtered negative air machines shall be set up within the work areas and run continuously through the completion of all non-friable work.
- 3. The Abatement Contractor shall coordinate the abatement schedule with General Contractor, RPS 205, and Carnow Conibear.
- The Abatement Contractor Representative is responsible for attendance at any preconstruction and or coordination meetings prior to mobilization and during all abatement activities.
- 5. Caution signs shall be posted adherent to specification requirements of OSHA 29 CFR 1926.1101(k)(6) at all potential entrances or barriers to the regulated abatement areas.
- Abatement contractor responsible for daily cleanup and disposal of debris generated during abatement activities.
- If utilized, worker decontamination enclosure systems shall be constructed in strict
  accordance with IDPH section 855.410. Clean room shall be sized to accommodate the
  needs of the work crew. Donning and Doffing of PPE outside of clean room is strictly
  prohibited.

### **EXTERIOR ABATEMENT NOTES:**

 The specific sequencing of the work to be determined and coordinated with the Owner and Window Contractor.

- Abatement of windows shall be conducted from the building exterior only. Interior building
  areas shall be sealed air tight with 6-mil poly and as necessary, rigid sheeting and framing at
  each window opening. At no time shall abatement activities be conducted from the building
  interior.
- General Contractor responsible for the removal and disposal of all interior window treatments and associated backing/supports.
- Abatement Contractor responsible for the removal and disposal of all existing screens.
- Abatement Contractor responsible for any interior damage exceeding 1" from window framing.
- 6. Abatement Contractor shall document existing conditions of and is responsible for the protection of any exterior landscaping, turf, concrete sidewalks, or interior furnishings from damage. Repair or replacement of surfaces damaged during the abatement process shall be the responsibility of the Abatement Contractor.
- 7. Abatement Contractor responsible for the temporary removal and set aside of any existing window air conditioners and associated supports and brackets. Removed A/C units and hardware shall be set on plywood sheeting within the room from where it was removed. Abatement Contractor is NOT responsible for reinstallation of the removed A/C units.
- 8. The Abatement Contractor is responsible for all demolition associated with the existing window systems. Following the abatement/demolition of the existing window system, the window opening shall be free of any clips, masonry, mortar drips, wood blocking / framing, etc that may interfere with the new window installation.
- 9. Interior plastic sheeting installed for abatement purposes shall be removed and disposed as abatement waste by the Abatement Contractor immediately following abatement activities.

### WINDOW / DOOR BOARD-UP NOTES:

- 1. When windows or doors are removed for abatement purposes, Abatement Contractor responsible for the board-up of building opening prior to abatement. Board-up requirements include, at a minimum, 2"x4" framing and 1/2" plywood sheathing. Board-up shall include 1 layer of 6mil poly sheeting on the exterior side of the board-up when necessary for protection from rain/water.
- Abatement Contractor responsible for the maintenance of board-up until removal by the Window Contractor.
- 3. The Abatement Contractor is expected to maintain board-up of up to 45 windows during the overall window replacement schedule.
- 4. Window Contractor responsible for removal of the board-up and to set aside board up materials for reuse by the Abatement Contractor.

### SCHEDULE:

PROJECT DESIGNER

- The work is scheduled for RPS205 Summer Break 2019, as follows:
- 2. NOTE: The exact start and stop dates may be modified for coordination purposes, however time frames to complete each abatement area shall not be exceeded.

	DRAWING HISTORY												
NO.	DATE	DRAWN BY:	CHECKED BY:	REMARKS									
1	12/07/2018	J. Kalingasan	E. Christian										
2	12/31/2018	A. Rodriguez	E. Christian	Addendum #1									
0													

Rockford Public Schools 501 7th Street Rockford, Illinois 61104 Asbestos Abatement
Hillman Elementary School
3701 Green Dale Drive
Rockford, Illinois 61109

Rod Harvey

IDPH #: 100-01548

GENERAL NOTES

SHEET TITLE:

DESIGNER SIGNATUR


ADDENDUM #1

Carnow, Conibear & Assoc., Ltd.
Environmental Consulting Services
600 W. Van Buren St., Suite 500, Chicago, IL 60607
t: 312.782.4486 f: 312.782.5145
www.ccaltd.com

DATE:
December 31, 2018
SHEET NO.

CA PROJECT NO.

CARNOW CONIBEAR

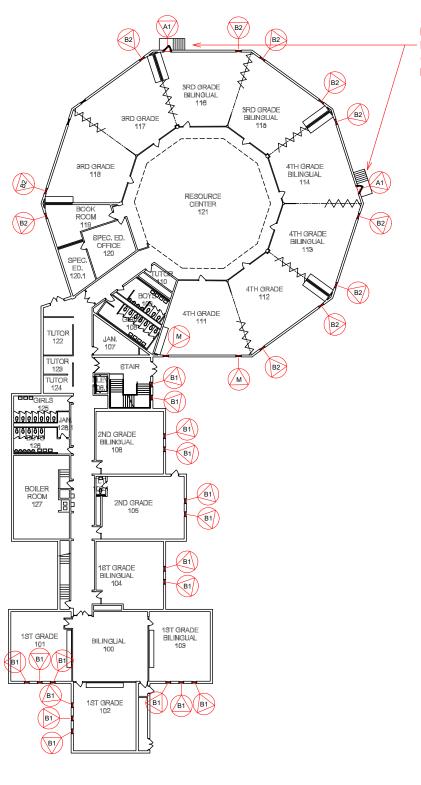

ABATEMENT CONTRACTOR TO INSTALL TEMPORARY WOOD FRAMING WITH BLOCKING AND POLY SHEETING ON THE INTERIOR OF THE DOOR SYSTEM TO ALLOW EXTERIOR REMOVAL OF THE EXISTING DOOR ASSEMBLY, ASSOCIATED CAULKING, AND FLOORING AT THRESHOLD.

### SCOPE OF WORK:

- Base Bit Item 1: Exterior removal and disposal of existing window assemblies including including the frames, and all asbestos-containing (ACM) interior and exterior perimeter caulk, glazing compounds, putty and construction mastics. Interior window sills to remain.
- 2. <u>Base Bid Item 2:</u> Removal and disposal of existing window assemblies, including the frames and all NON-ACM interior and exterior perimeter caulk, glazing compounds, putty, and Construction mastics.
- Alternate Bid Item 1: Removal and disposal of existing door, frames, associated hardware, and all NON-ACM caulking and sealants. Removal and disposal of approximately five (5) square feet of Asbestos-Containing flooring (All Layers) at the interior of each door opening.
- 4. All work per specification number 02132 and all applicable IDPH, IEPA and OSHA regulations.
- The specific sequencing of the work to be determined and coordinated with the Owner and the Window Contractor.
   Refer to architectural drawings for window and door assembly details.
- In areas with drop ceiling Abatement Contractor to remove ceiling tiles and disassemble grid as needed to access windows. Salvage for reinstallation. Abatement Contractor not responsible for reinstallation.
- 7. If necessary to protect interior of rooms, Abatement Contractor to install temporary wood framing with blocking and poly sheeting on the interior of the window frame system to allow exterior removal of existing window assembly, associated caulk, and glazing.

	WINDOW DEMOLITION / EXTERIOR APPROXIMATE ASBESTOS ABATEMENT WORK SCHEDULE:										
TAG	AG START END DATE WORK SEQUENCE										
M	2/15/2019	2/15/2019	Base Bid Work - Exterior asbestos abatement / Window Demolition Mock-up Location								
B1	6/10/2019	8/19/19	Base Bid Item 1 - Exterior asbestos abatement / Window Demolition								
B2	6/10/2019	8/19/19	Base Bid Item 2 - Exterior Window Demolition (NON-ACM)								
(A1)	6/10/2019	8/19/19	Alternate Bid item 1 - Exterior Door Demolition Interior ACM Flooring Abatement (Approximately 5 square feet, all layers)								

FIRST FLOOR
EXTERIOR ASBESTOS ABATEMENT

1/32" = 1'
N

PROJECT DESIGNER

DRAWING HISTORY											
NO.	DATE	DRAWN BY:	CHECKED BY:	REMARKS							
1	12/07/2018	J. Kalingasan	E. Christian								
2	12/31/2018	A. Rodriguez	E. Christian	Addendum #1							
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Rockford Public Schools 501 7th Street Rockford, Illinois 61104 Asbestos Abatement
Hillman Elementary School
3701 Green Dale Drive
Rockford, Illinois 61109

Rod Harvey

IDPH #: 100-01548

SHEET TITLE:

EXTERIOR ASBESTOS ABATEMENT FIRST FLOOR ADDENDUM #1/


Carnow, Conibear & Assoc., Ltd.
Environmental Consulting Services
600 W. Van Buren St., Suite 500, Chicago, IL 60607
t: 312.782.4486 f: 312.782.5145
www.ccaltd.com

CCA PROJECT NO.

DATE:
December 31, 2018



M ASB-1

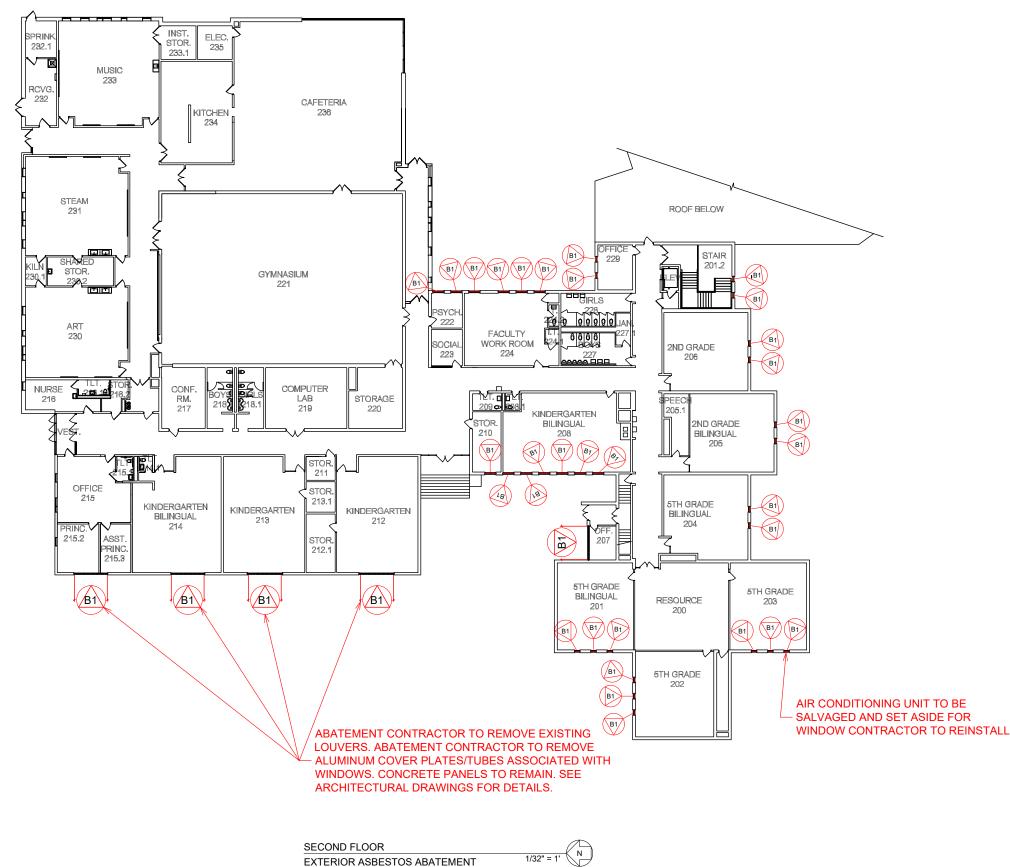

### SCOPE OF WORK:

- Base Bit Item 1: Exterior removal and disposal of existing window assemblies including including the frames, and all asbestos-containing (ACM) interior and exterior perimeter caulk, glazing compounds, putty and construction mastics. Interior window sills to remain.
- Base Bid Item 2: Removal and disposal of existing window assemblies, including the frames and all NON-ACM interior and exterior perimeter caulk, glazing compounds, putty, and Construction mastics.
- 3. Alternate Bid Item 1: Removal and disposal of existing door, frames, associated hardware, and all NON-ACM caulking and sealants. Removal and disposal of approximately five (5) square feet of Asbestos-Containing flooring (All Layers) at the interior of each door opening.
- 4. All work per specification number 02132 and all applicable IDPH, IEPA and OSHA regulations.
- The specific sequencing of the work to be determined and coordinated with the Owner and the Window Contractor.
   Refer to architectural drawings for window and door assembly details.
- In areas with drop ceiling Abatement Contractor to remove ceiling tiles and disassemble grid as needed to access windows. Salvage for reinstallation. Abatement Contractor not responsible for reinstallation.
- 7. If necessary to protect interior of rooms, Abatement Contractor to install temporary wood framing with blocking and poly sheeting on the interior of the window frame system to allow exterior removal of existing window assembly, associated caulk, and glazing.

# WINDOW DEMOLITION / EXTERIOR APPROXIMATE ASBESTOS ABATEMENT WORK SCHEDULE:

	WORK SCHEDULE:											
TAG	START DATE	END DATE	WORK SEQUENCE									
M	2/15/2019	2/15/2019	Base Bid Work - Exterior asbestos abatement / Window Demolition Mock-up Location									
B1	6/10/2019	8/19/19	Base Bid Item 1 - Exterior asbestos abatement / Window Demolition									
B2	6/10/2019	8/19/19	Base Bid Item 2 - Exterior Window Demolition (NON-ACM)									
(A1)	6/10/2019	8/19/19	Alternate Bid item 1 - Exterior Door Demolition Interior ACM Flooring Abatement (Approximately 5 square feet, all layers)									

EXTERIOR

Rockford Public Schools 501 7th Street Rockford, Illinois 61104

DRAWING HISTORY

CHECKED BY:

E. Christian

E. Christian

REMARKS

Addendum #1

DATE

12/07/2018

12/31/2018

DRAWN BY

J. Kalingasar

A. Rodriguez

PROJECT NAME: Asbestos Abatement
Hillman Elementary School
3701 Green Dale Drive
Rockford, Illinois 61109

Rod Harvey

IDPH #: 100-01548

PROJECT DESIGNER

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EXTERIOR ASBESTOS ABATEMENT FIRST FLOOR ADDENDUM #1/

Carnow, Conibear & Assoc., Ltd. Environmental Consulting Services 600 W. Van Buren St., Suite 500, Chicago, IL 60607 t: 312.782.4486 f: 312.782.5145 www.ccaltd.com CCA PROJECT NO.
--DATE:
December 31, 2018

CARNOW CONIBEAR

OW ASB-2

**PROJECT** 

# WINDOW REPLACEMENT PROJECT FOR FROBERG ELEMENTARY

**4555 20TH STREET** ROCKFORD, ILLINOIS 61109

**OWNER** 

# ROCKFORD PUBLIC SCHOOL DISTRICT 205

**501 SEVENTH STREET** ROCKFORD, ILLINOIS 61104





ARCHITECT OF RECORD	CIVIL	STRUCTURAL	MECHANICAL / ELECTRICAL / PLUMBING	FOOD SERVICE
RICHARD L. JOHNSON ASSOCIATES 4703 Charles Street Rockford IL. 61108 PHONE: 815/398-1231 FAX 815/398-1280 www.rljarch.com IL. Design Firm No. 187-000524  EXPIRES 11-30-2018				
SHEET INDEX			BID INDEX	STATE MAP
TITLE SHEET  TIO1 TITLE SHEET  ARCHITECTURAL  A101 DEMOLITION PLAN A102 DEMOLITION EXTERIOR ELEVATIONS A103 REVISED PLAN A104 REVISED EXTERIOR ELEVATIONS A105 FRAME TYPES A106 HEAD, JAMB AND SILL DETAILS			ALTERNATE BID #F1: PROVIDE NEW DOORS, FRAMES AND HARDWARE AT THE GYMNASIUM	ROCKFORD CHEAGO PROCK BLAD PROMINGELLO  BAST ST. ADMIS

CODE PROJECT SHALL BE CONSTRUCTED FOLLOWING THE 2015 INTERNATIONAL BUILDING CODE.

MOCK-UP DATES December 7, 2018 MOCK-UP SHOP DRAWINGS COMPLETE: **December 14, 2018** REVIEW OF MOCK-UP SHOP DRAWINGS COMPLETE BY ARCHITECT: REMOVAL OF 1 WINDOW AND INSTALLATION OF TEMPORARY **ENCLOSURE BY SEPARATE CONTRACTOR** February 15, 2019 WINDOW CONTRACTOR TO REMOVE TEMPORARY ENCLOSURE AND **INSTALL WINDOW:** February 16, 2019 **MOCK-UP TESTING:** February 18, 2019

PROJECT START / COMPLETION DATES PROJECT START: June 10, 2019 PROJECT SUBSTANTIALLY COMPLETE: July 19, 2019 July 26, 2019 FINAL COMPLETION - ALL PUNCH LIST ITEMS:

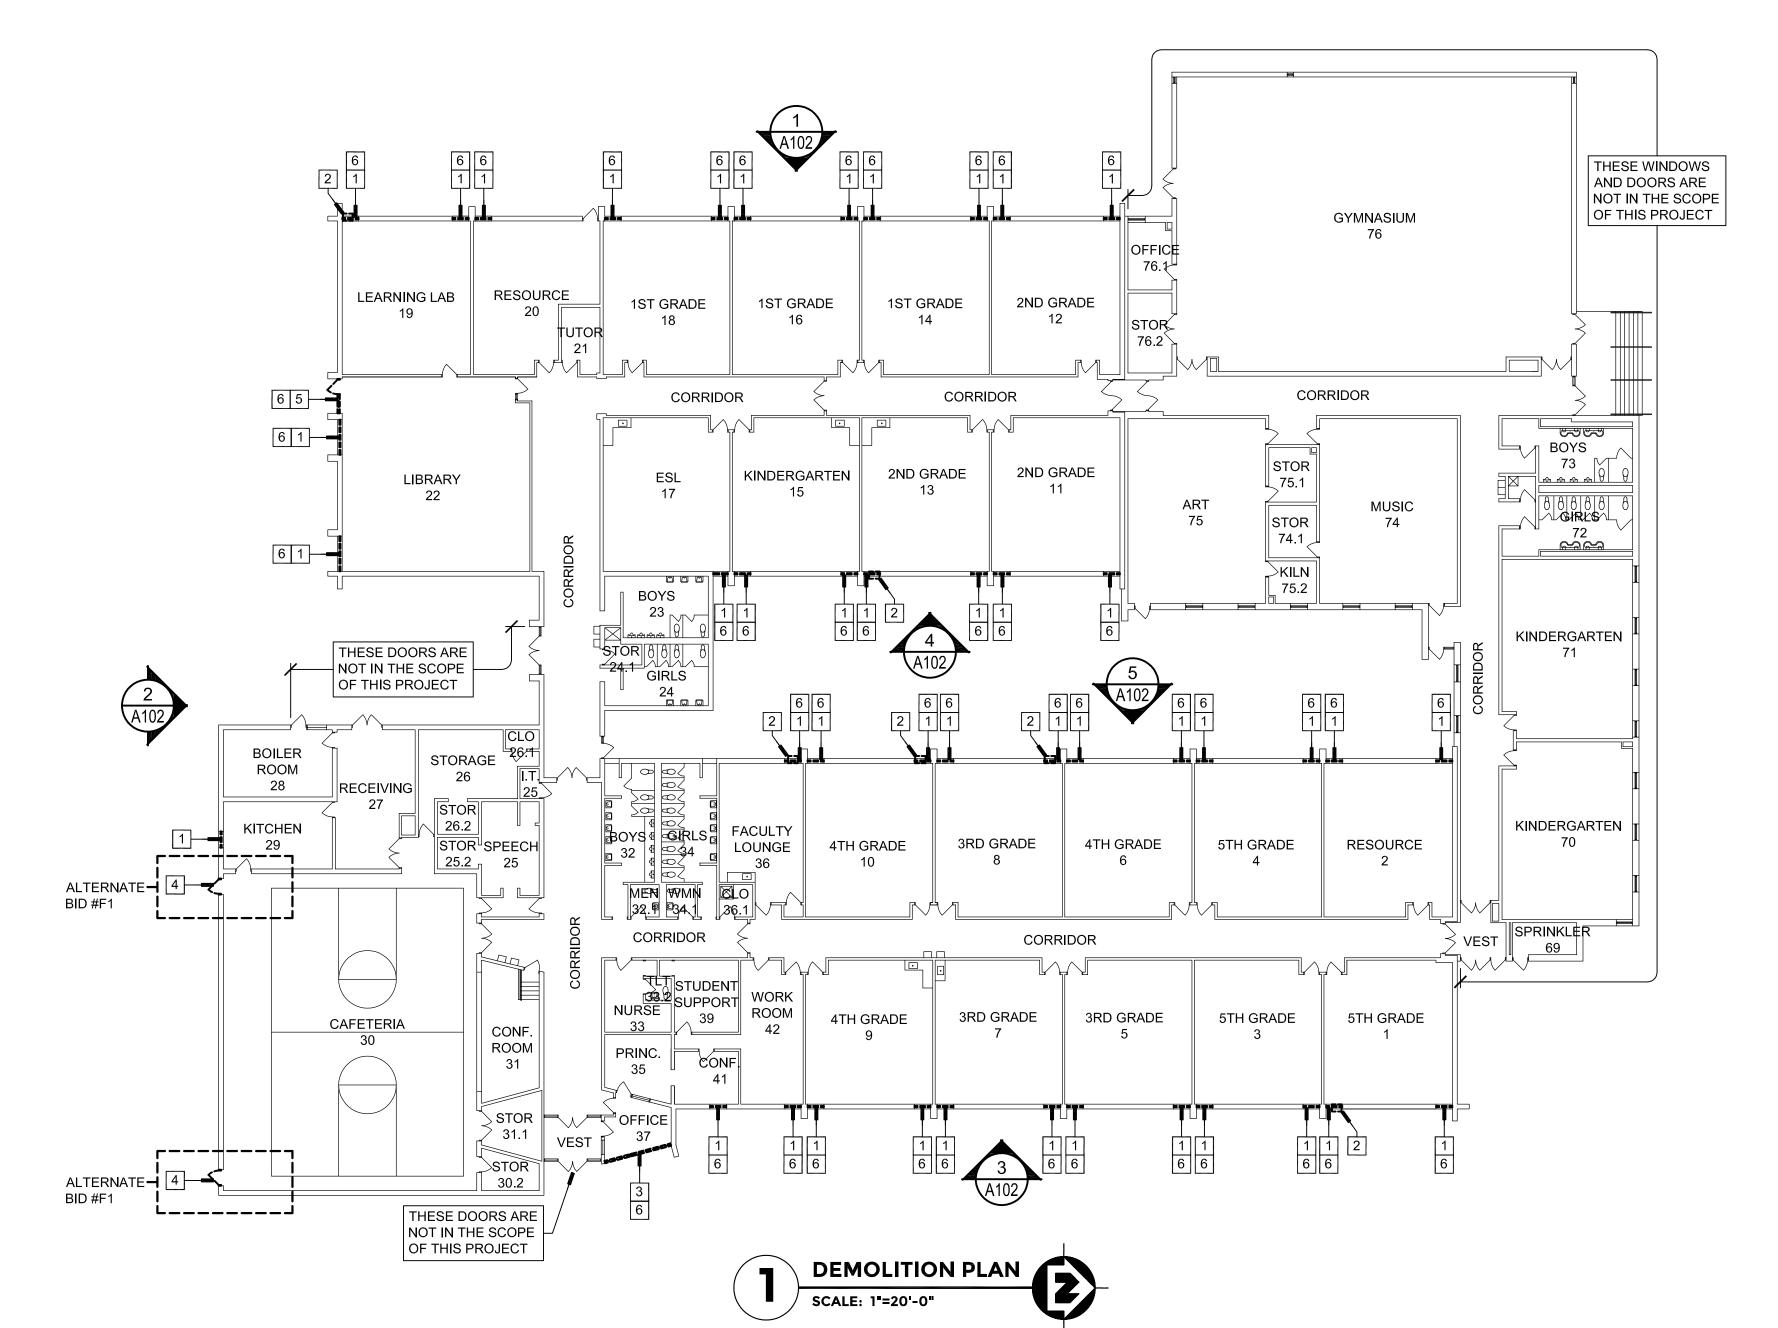

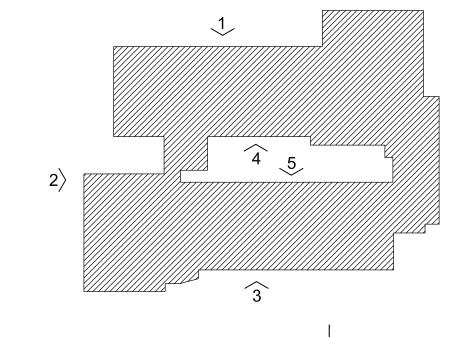




# GENERAL DEMOLITION NOTES


- . THE DEMOLITION PLAN IS PROVIDED AS AID IN PLANNING AND DOES NOT RELIEVE THE CONTRACTOR'S RESPONSIBILITY IN FIELD VERIFYING THE EXISTING JOB SITE.
- 2. PROVIDE ALL TEMPORARY SHORING AS REQUIRED TO SUPPORT STRUCTURES AND FINISHES TO REMAIN.
- . THE CONTRACTOR SHALL COORDINATE ALL FINAL LOCATIONS OF AIR CONDITIONERS WITH THE OWNER / ARCHITECT.
- . ANY WALLS OR CEILINGS DAMAGED BY THE ASBESTOS REMOVAL CONTRACTOR SHALL BE REPAIRED AND PAINTED BY THE ASBESTOS REMOVAL CONTRACTOR. ANY WALLS OR CEILINGS DAMAGED DURING THE COURSE OF THE WINDOW INSTALLATION PROJECT SHALL BE REPAIRED AND PAINTED BY THE WINDOW CONTRACTOR.
- SEE DEMOLITION ELEVATIONS FOR ADDITIONAL INFORMATION.
- EXISTING WINDOW TREATMENTS REMOVED BY ASBESTOS CONTRACTOR, SALVAGED AND TURNED OVER TO THE WINDOW CONTRACTOR FOR REINSTALLATION.
- ASBESTOS CONTRACTOR AND WINDOW CONTRACTOR TO REPORT ANY DETERIORATED LINTELS TO ARCHITECT AND OWNER. OWNER TO REPAIR OR REPLACE AS REQUIRED.

## DEMOLITION BOX NOTES

- 1 ASBESTOS CONTRACTOR HIRED SEPARATELY BY OWNER WILL REMOVE ALUMINUM WINDOW AND CAULKING AND INSTALL PLYWOOD AND FRAMING TO FILL IN THE OPENINGS. WINDOW CONTRACTOR TO REMOVE PLYWOOD AND FRAMING AND TURN OVER TO THE ASBESTOS CONTRACTOR.
- 2 ASBESTOS CONTRACTOR HIRED SEPARATELY BY OWNER SHALL REMOVE EXISTING AIR CONDITIONER AND SUPPORTS AND TURN OVER TO THE WINDOW CONTRACTOR FOR REINSTALLATION.
- 3 ASBESTOS CONTRACTOR HIRED SEPARATELY BY OWNER WILL REMOVE HOLLOW METAL WINDOW AND CAULKING AND INSTALL PLYWOOD AND FRAMING TO FILL IN THE OPENINGS. WINDOW CONTRACTOR TO REMOVE PLYWOOD AND FRAMING AND TURN OVER TO THE ASBESTOS CONTRACTOR.
- 4 UNDER ALTERNATE BID #F1: ASBESTOS CONTRACTOR HIRED SEPARATELY BY OWNER WILL REMOVE HOLLOW METAL DOOR, FRAME, HARDWARE AND CAULKING AND INSTALL PLYWOOD AND FRAMING TO FILL IN THE OPENINGS. WINDOW CONTRACTOR TO REMOVE PLYWOOD AND FRAMING AND TURN OVER TO THE ASBESTOS CONTRACTOR.
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- 6 ASBESTOS CONTRACTOR HIRED SEPARATELY BY OWNER TO REMOVE EXISTING WINDOW TREATMENT, SALVAGE AND TURN OVER TO THE WINDOW CONTRACTOR FOR REINSTALLATION.

A102

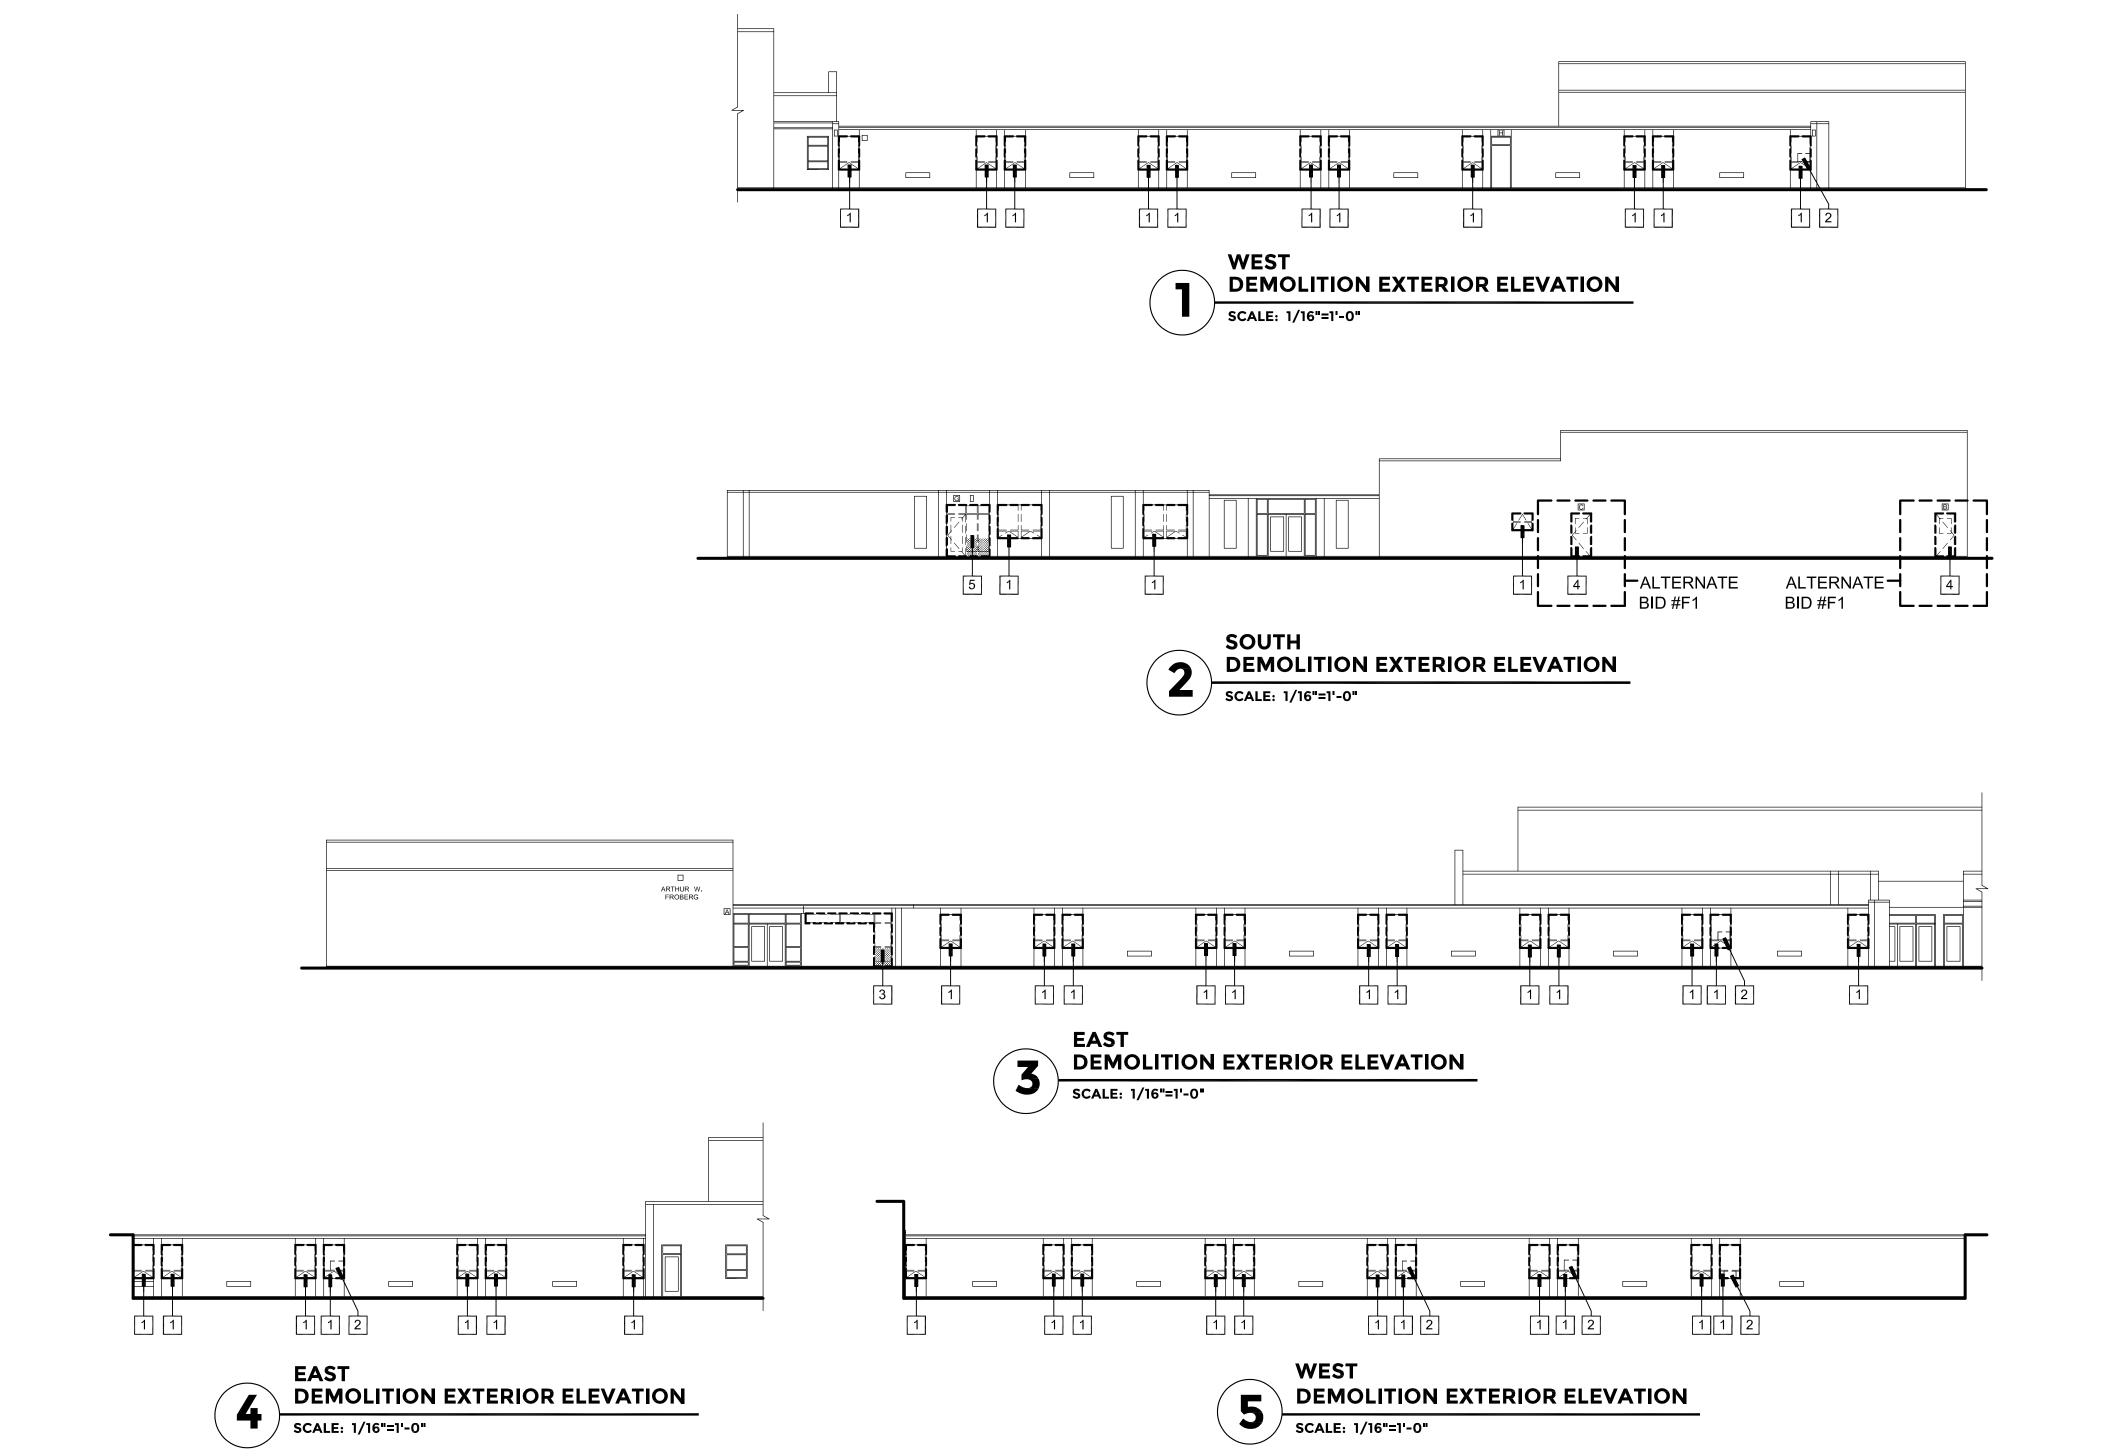

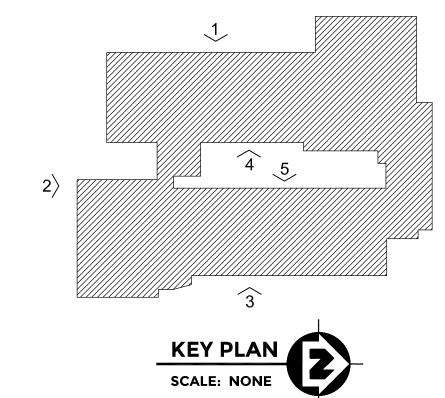

## GENERAL DEMOLITION NOTES

- THE DEMOLITION PLAN IS PROVIDED AS AID IN PLANNING AND DOES NOT RELIEVE THE CONTRACTOR'S RESPONSIBILITY IN FIELD VERIFYING THE EXISTING JOB SITE.
- PROVIDE ALL TEMPORARY SHORING AS REQUIRED TO SUPPORT STRUCTURES AND FINISHES TO REMAIN.
- THE CONTRACTOR SHALL COORDINATE ALL FINAL LOCATIONS OF AIR CONDITIONERS WITH THE OWNER / ARCHITECT.
- ANY WALLS OR CEILINGS DAMAGED BY THE ASBESTOS REMOVAL CONTRACTOR SHALL BE REPAIRED AND PAINTED BY THE ASBESTOS REMOVAL CONTRACTOR. ANY WALLS OR CEILINGS DAMAGED DURING THE COURSE OF THE WINDOW INSTALLATION PROJECT SHALL BE REPAIRED AND PAINTED BY THE WINDOW CONTRACTOR.
- SEE DEMOLITION ELEVATIONS FOR ADDITIONAL INFORMATION.
- . EXISTING WINDOW TREATMENTS REMOVED BY ASBESTOS CONTRACTOR, SALVAGED AND TURNED OVER TO THE WINDOW CONTRACTOR FOR REINSTALLATION.
- ASBESTOS CONTRACTOR AND WINDOW CONTRACTOR TO REPORT ANY DETERIORATED LINTELS TO ARCHITECT AND OWNER. OWNER TO REPAIR OR REPLACE AS REQUIRED.

## DEMOLITION BOX NOTES


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REMOVE EXISTING WINDOW TREATMENT, SALVAGE AND TURN OVER

6 ASBESTOS CONTRACTOR HIRED SEPARATELY BY OWNER TO

TO THE WINDOW CONTRACTOR FOR REINSTALLATION.

A103

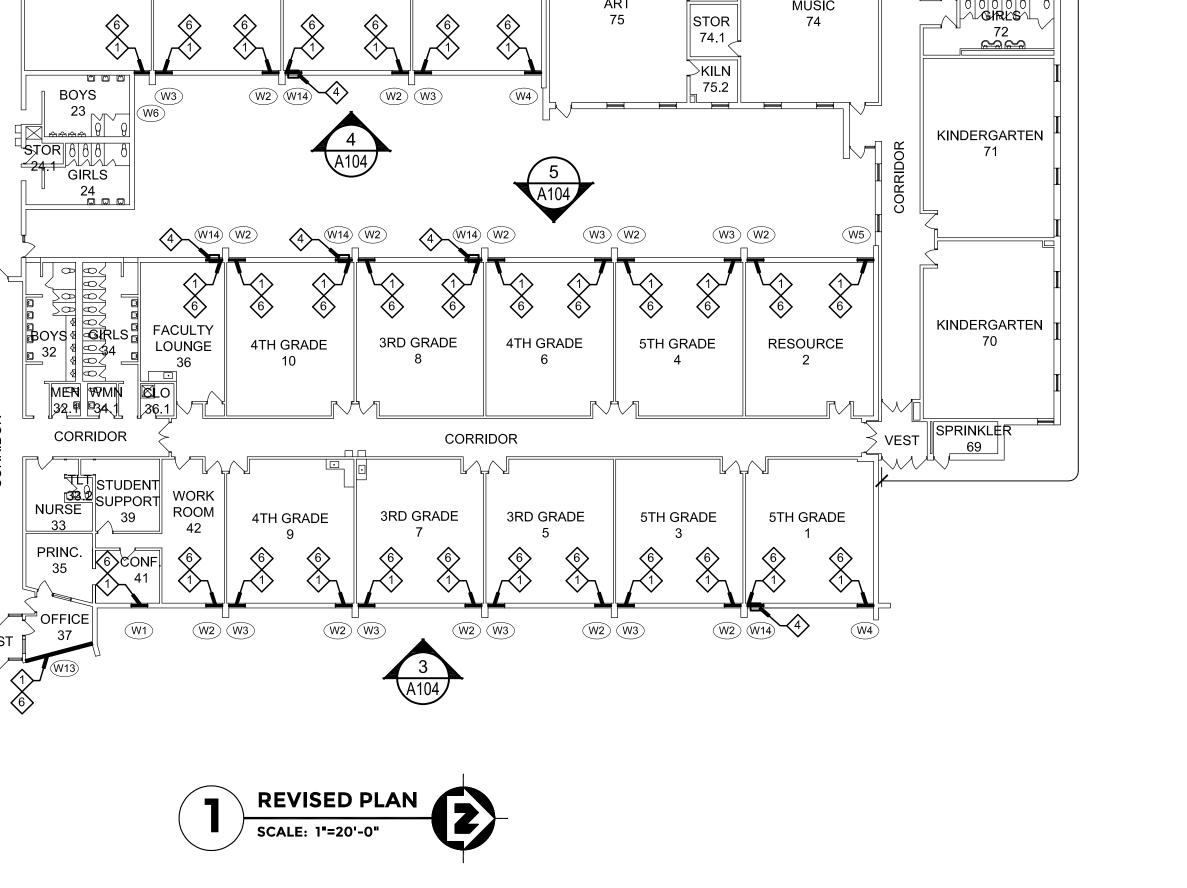

2ND GRADE

2ND GRADE

STOR

76.2

LEARNING LAB

LIBRARY

THESE DOORS ARE

NOT IN THE SCOPE OF THIS PROJECT

RECEIVING

CAFETERIA

STORAGE

STOR

26.2

STORUSPEECH

ROOM

STOR

> 31.1

STOR

30.2

THESE DOORS ARE

NOT IN THE SCOPE

OF THIS PROJECT

25.2 25

A104

BOILER

ROOM

28

KITCHEN

┍灰╼╼╫╼┈╼╸

W12 DOOR F103

ALTERNATE W11 DOOR F102

BID #F1

ALTERNATE -

BID #F1

\_\_\_ DOOR F101

RESOURCE

**1ST GRADE** 

ESL

CORRIDOR


1ST GRADE

KINDERGARTEN

1ST GRADE

2ND GRADE

CORRIDOR

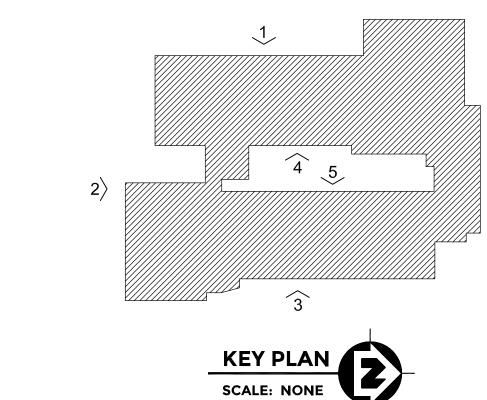

# GENERAL NOTES

THESE WINDOWS AND DOORS ARE NOT IN THE SCOPE OF THIS PROJECT

73

□ J BOYS

GYMNASIUM

MUSIC

CORRIDOR


75.1


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- WINDOW AND ENTRANCE FRAMES EACH SIDE OF FRAMES. CONTRACTOR IS RESPONSIBLE FOR ADDING STRUCTURAL
- REINFORCEMENT AS REQUIRED TO MEET STRUCTURAL LOADING FOR ALL WINDOW TYPES.
- WINDOWS SHALL OPEN AS FAR AS POSSIBLE. AT END OF PROJECT THE OWNER/ARCHITECT SHALL DETERMINE WHICH OPERABLE WINDOWS WILL REQUIRE A 4" MAXIMUM OPENING. CONTRACTOR TO ADJUST OPENING AS REQUIRED.
- PROVIDE A PROPER CAULK JOINT BETWEEN A/C UNITS AND METAL PANELS.
- PROVIDE TREATED WOOD SHIMS AND BLOCKING AS REQUIRED FOR WINDOW INSTALLATIONS. APPLY A COATING TO THE WOOD BLOCKING SO AS TO NOT CHEMICALLY REACT WITH THE ALUMINUM.
- CONTRACTOR TO RESTORE ANY DISTURBED GRASS AREAS WITH SEED BACK TO ORIGINAL CONDITIONS AFTER WORK IS COMPLETE.
- CONTRACTOR TO VERIFY EXACT LOCATIONS AND SIZES OF AIR CONDITIONER UNITS IN NEW WINDOW SYSTEM WITH OWNER/ARCHITECT
- LINTELS AT WINDOWS TO BE PAINTED THE SAME COLOR AS WINDOWS.
- D. CONTRACTOR TO PROVIDE INTERIOR METAL TRIM AT FLOORS, WALLS AND CEILINGS AS REQUIRED TO COVER ANY EXPOSED CONSTRUCTION WHETHER SHOWN ON DETAILS OR NOT.
- . INSULATED METAL PANEL COLOR TO MATCH WINDOW FRAMING COLOR. VERIFY COLOR WITH OWNER.
- 12. CAULK COLOR TO MATCH WINDOW FRAMING COLOR.
- 13. WINDOW CONTRACTOR SHALL BE RESPONSIBLE FOR THE FINAL CLEANING OF THE NEW WINDOWS ON THE EXTERIOR AND THE
- 4. DIMENSIONS SHOWN ARE TAKEN FROM EXISTING INTERIOR JAMB TO EXISTING INTERIOR JAMB, AND FROM EXISTING INTERIOR SILL TO EXISTING INTERIOR HEAD.
- 5. OUTSIDE FACE OF NEW FRAME TO LINE WITH OUTSIDE FACE OF EXISTING FRAME UNLESS NOTED OTHERWISE.

# RENOVATION KEY NOTES

- WINDOW CONTRACTOR TO INSTALL NEW ALUMINUM WINDOW SYSTEM AND GLAZING COMPLETE.
- 2 WINDOW CONTRACTOR TO INSTALL NEW ALUMINUM DOOR, FRAME, HARDWARE AND GLAZING COMPLETE.
- (3) UNDER ALTERNATE BID #F1: WINDOW CONTRACTOR TO INSTALL NEW ALUMINUM DOOR, FRAME, HARDWARE AND GLAZING COMPLETE.
- 4 WINDOW CONTRACTOR TO INSTALL EXISTING AIR CONDITIONER IN NEW INSULATED METAL PANEL (GL-2). REINSTALL EXISTING A/C SUPPORTS. INSTALL SEALANT BETWEEN THE PANEL AND THE A/C UNIT TO MATCH
- 5 THIS WINDOW TO BE A MOCK-UP WINDOW. SEE SPECIFICATIONS.
- (6) WINDOW CONTRACTOR TO REINSTALL SALVAGED SHADE.

A104

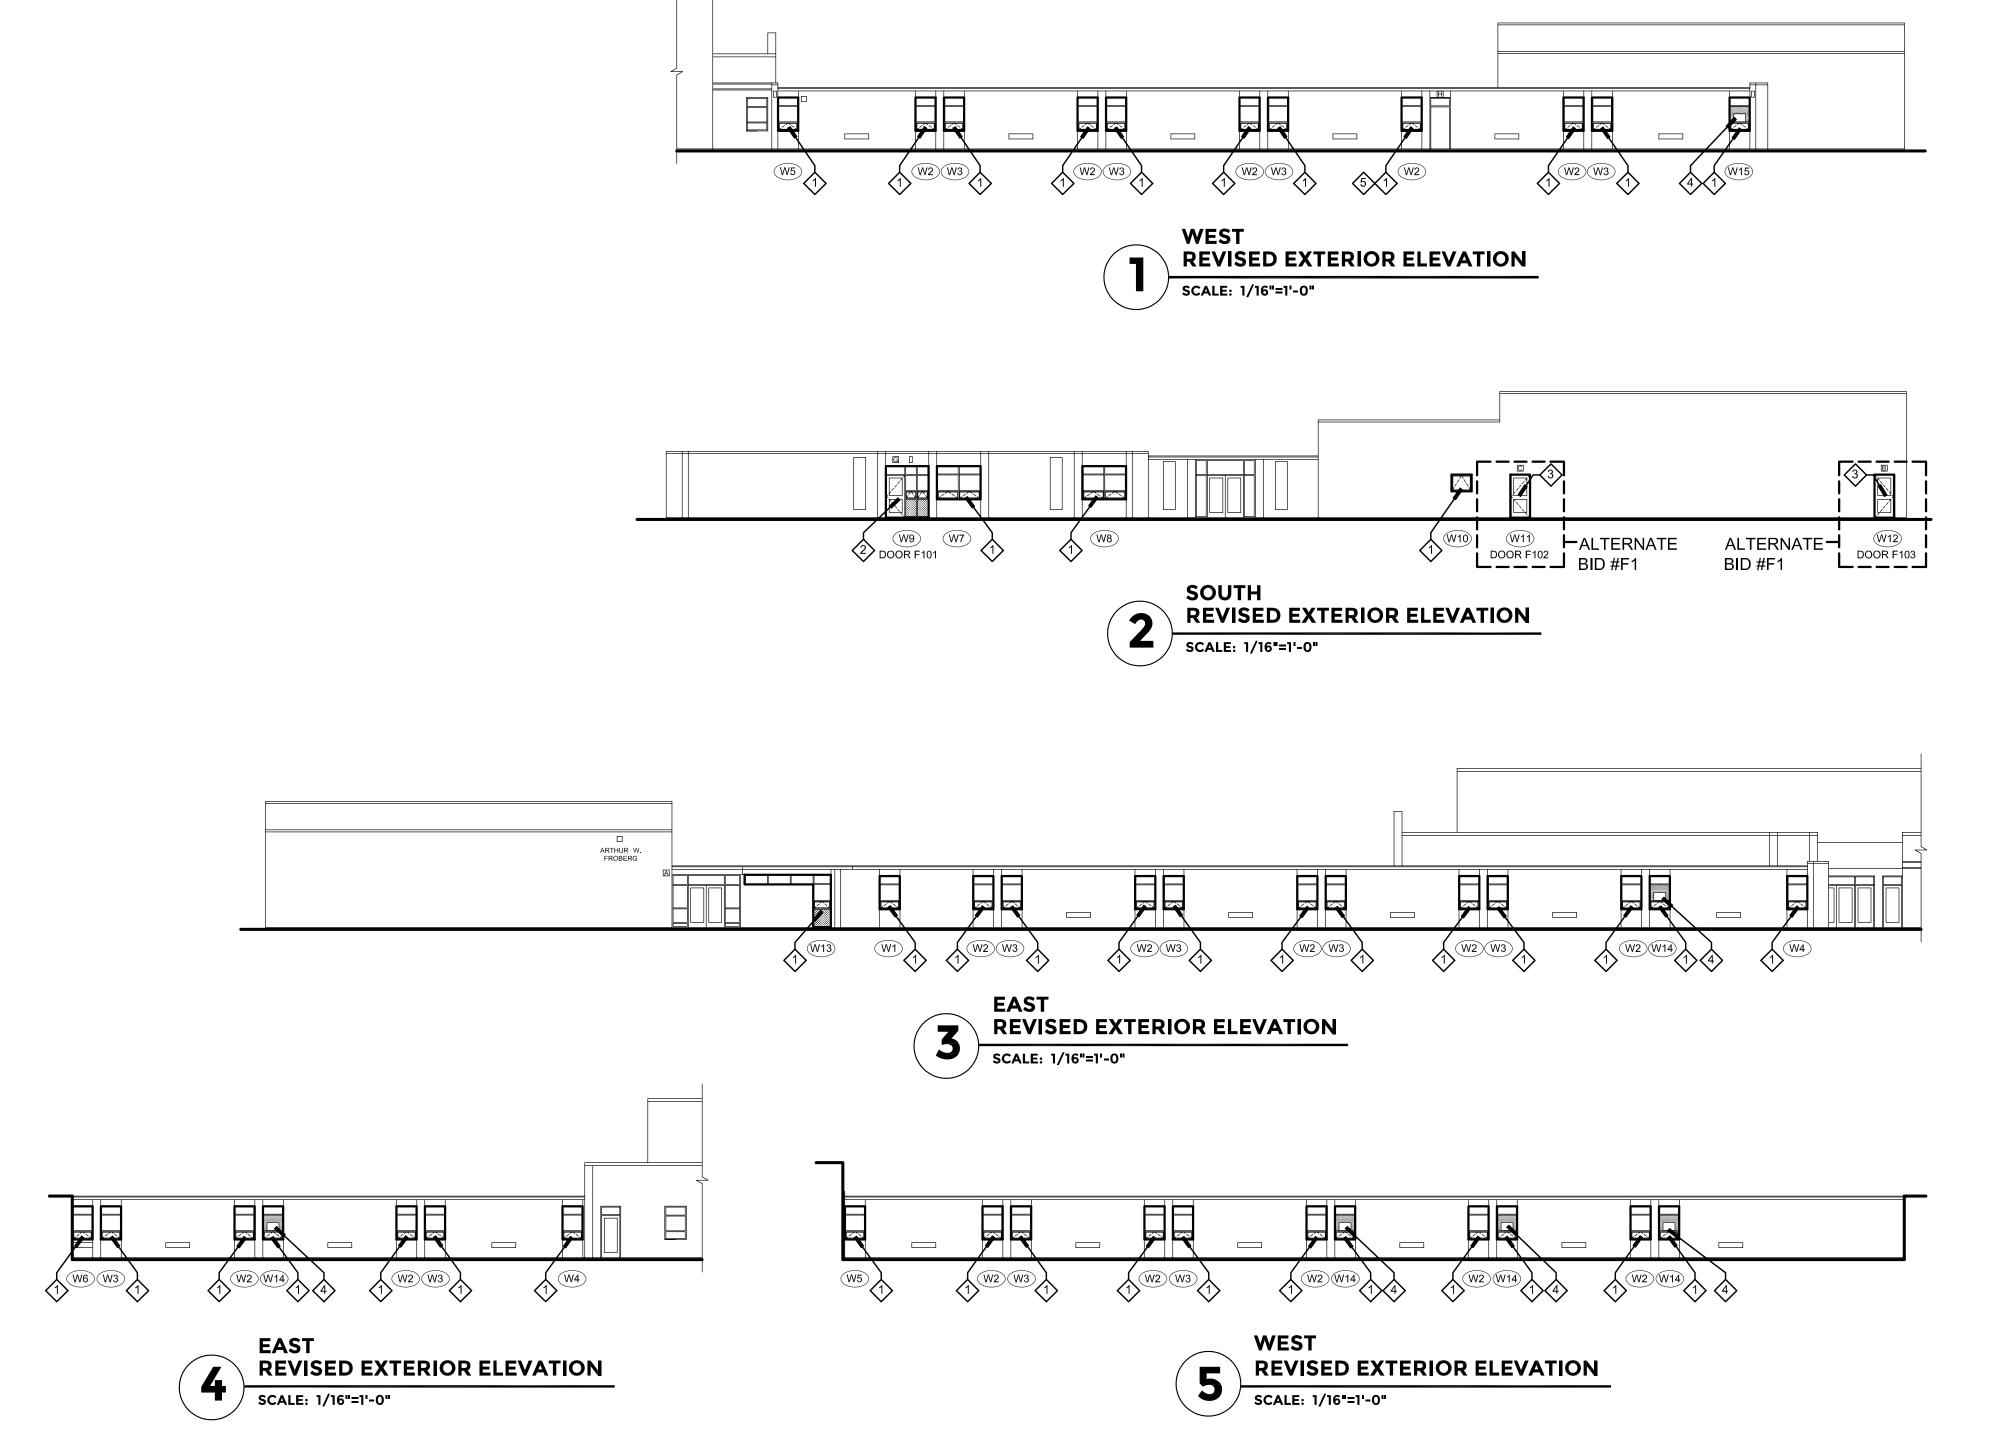

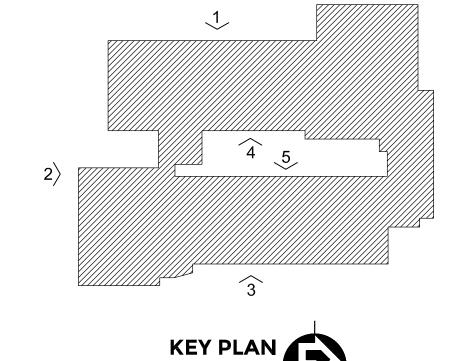

# GENERAL NOTES

- THE CONTRACTOR SHALL VERIFY ALL EXISTING WINDOW DIMENSIONS PRIOR TO BIDDING. THE DIMENSIONS ON THE DRAWING ARE +/-.
- PROVIDE BACKER ROD AND SEALANT AROUND PERIMETER OF NEW WINDOW AND ENTRANCE FRAMES - EACH SIDE OF FRAMES.
- CONTRACTOR IS RESPONSIBLE FOR ADDING STRUCTURAL REINFORCEMENT AS REQUIRED TO MEET STRUCTURAL LOADING FOR ALL WINDOW TYPES.
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- CONTRACTOR TO VERIFY EXACT LOCATIONS AND SIZES OF AIR CONDITIONER UNITS IN NEW WINDOW SYSTEM WITH OWNER/ARCHITECT
- LINTELS AT WINDOWS TO BE PAINTED THE SAME COLOR AS WINDOWS.
- ). CONTRACTOR TO PROVIDE INTERIOR METAL TRIM AT FLOORS, WALLS AND CEILINGS AS REQUIRED TO COVER ANY EXPOSED CONSTRUCTION WHETHER SHOWN ON DETAILS OR NOT.
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- DIMENSIONS SHOWN ARE TAKEN FROM EXISTING INTERIOR JAMB TO EXISTING INTERIOR JAMB, AND FROM EXISTING INTERIOR SILL TO EXISTING INTERIOR HEAD.
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- 5 THIS WINDOW TO BE A MOCK-UP WINDOW. SEE SPECIFICATIONS.
- 6 WINDOW CONTRACTOR TO REINSTALL SALVAGED SHADE.

A105

GENERAL NOTES

- THE CONTRACTOR SHALL VERIFY ALL EXISTING WINDOW DIMENSIONS PRIOR TO BIDDING. THE DIMENSIONS ON THE DRAWING ARE +/-.
- PROVIDE BACKER ROD AND SEALANT AROUND PERIMETER OF NEW WINDOW AND ENTRANCE FRAMES - EACH SIDE OF FRAMES.
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- CONTRACTOR TO RESTORE ANY DISTURBED GRASS AREAS WITH SEED BACK TO ORIGINAL CONDITIONS AFTER WORK IS COMPLETE.
- CONTRACTOR TO VERIFY EXACT LOCATIONS AND SIZES OF AIR
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BENOVATION MEM NOTES

- 3. WINDOW CONTRACTOR SHALL BE RESPONSIBLE FOR THE FINAL CLEANING OF THE NEW WINDOWS ON THE EXTERIOR AND THE
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- 5. OUTSIDE FACE OF NEW FRAME TO LINE WITH OUTSIDE FACE OF EXISTING FRAME UNLESS NOTED OTHERWISE.


SEE SCHEDULE FOR GLASS TYPES

DOOR TYPES

SCALE: 1/4"=1'-0"


GLASS TYPES GL-1 1" INSULATED TINTED TEMPERED GLASS GL-2 | 1" INSULATED METAL PANEL GL-3 | 1" INSULATED OBSCURE TEMPERED GLASS


DOC	DR :	SCHI	EDUL	. E								
DOOR	DOORS		DOOR TYPE FRAMES		6							
NO.	SG/PR	WIDTH	HEIGHT	THICK	MTL	ELEV.	MTL	ELEV.	DOOR GLAZING	HDWR GROUP	LABEL	REMARKS
F101	SG	3'-0"	7'-0"	2"	AL	D1	AL	W9	GL-1	01	NONE	-
F102	SG	3'-0"	7'-0"	2"	AL	D1	AL	W11	GL-1	01	NONE	-
F103	SG	3'-0"	7'-0"	2"	AL	D1	AL	W12	GL-1	01	NONE	-

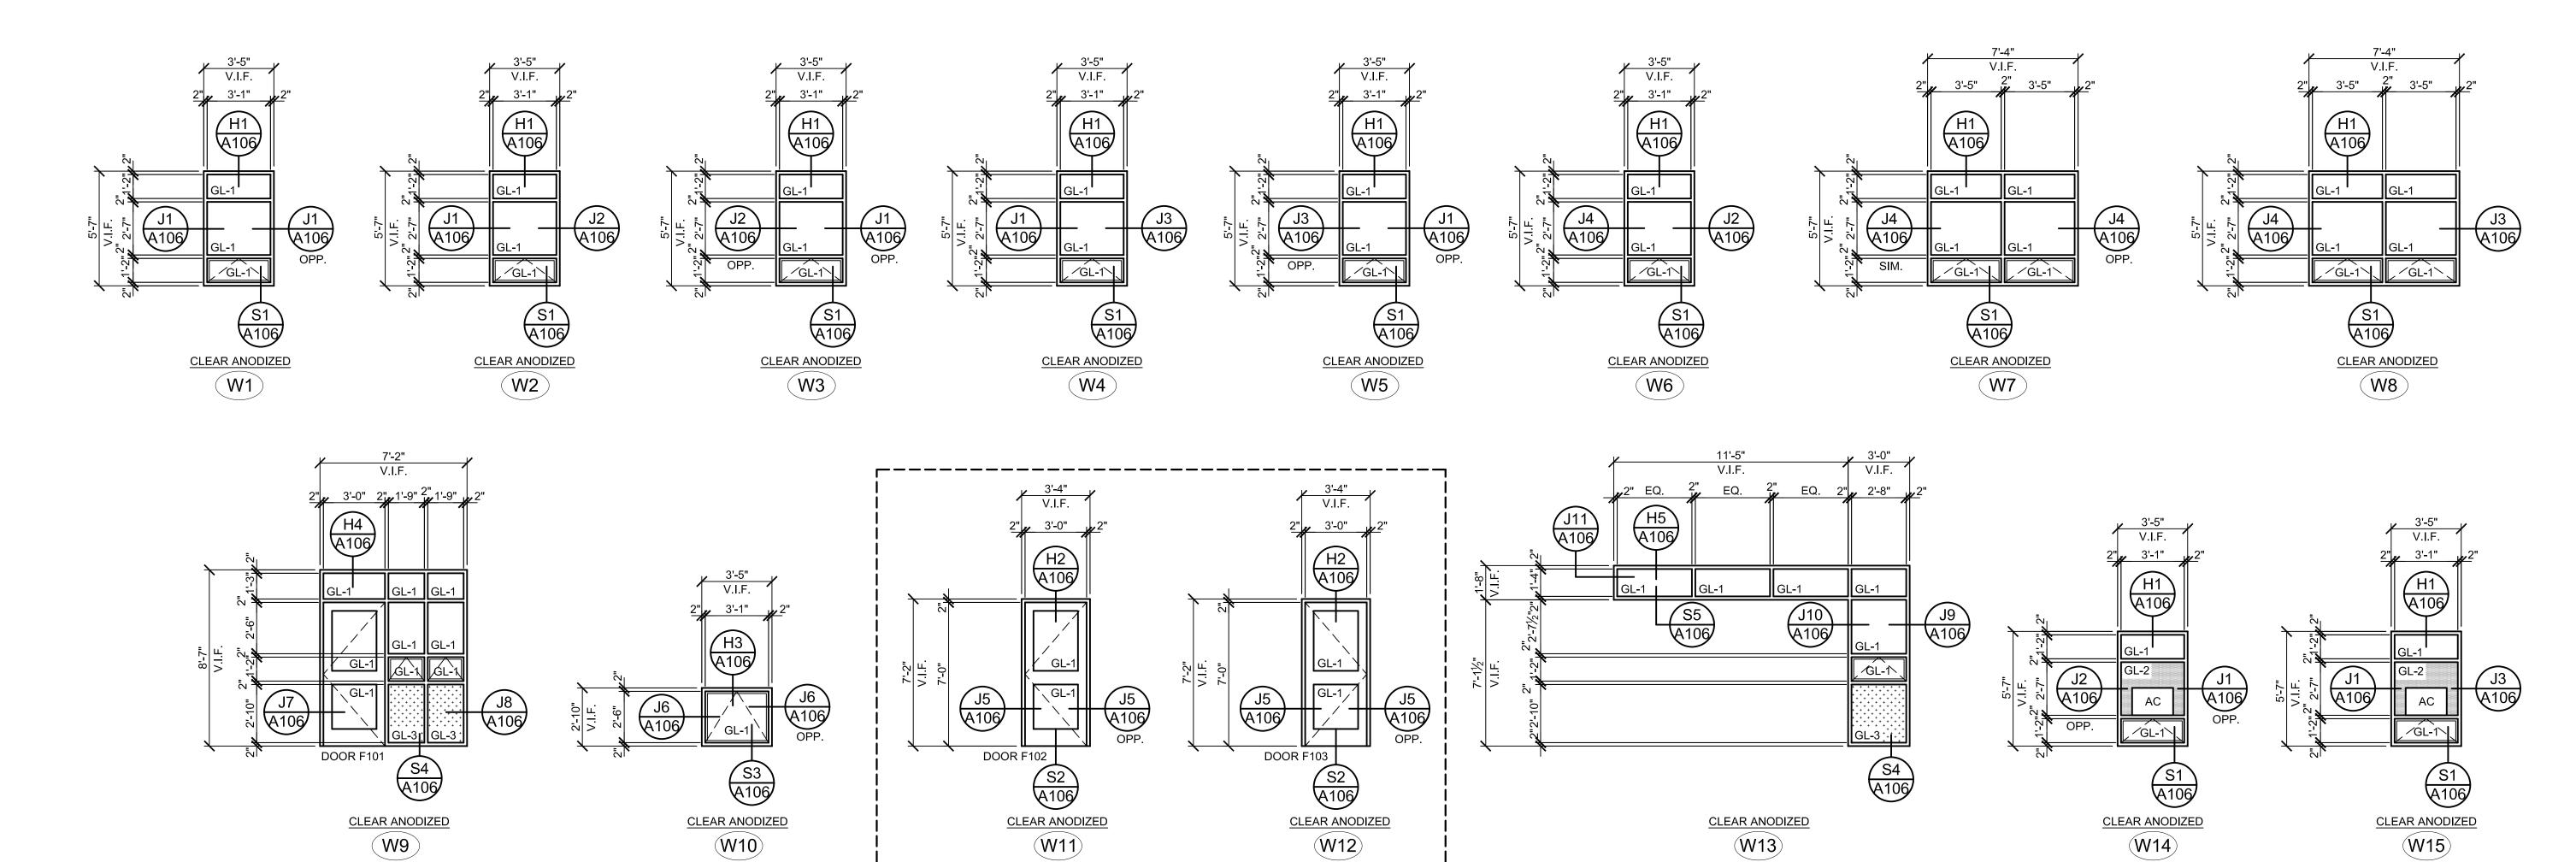

ALTERNATE BID #F1



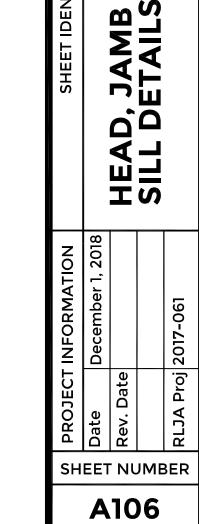

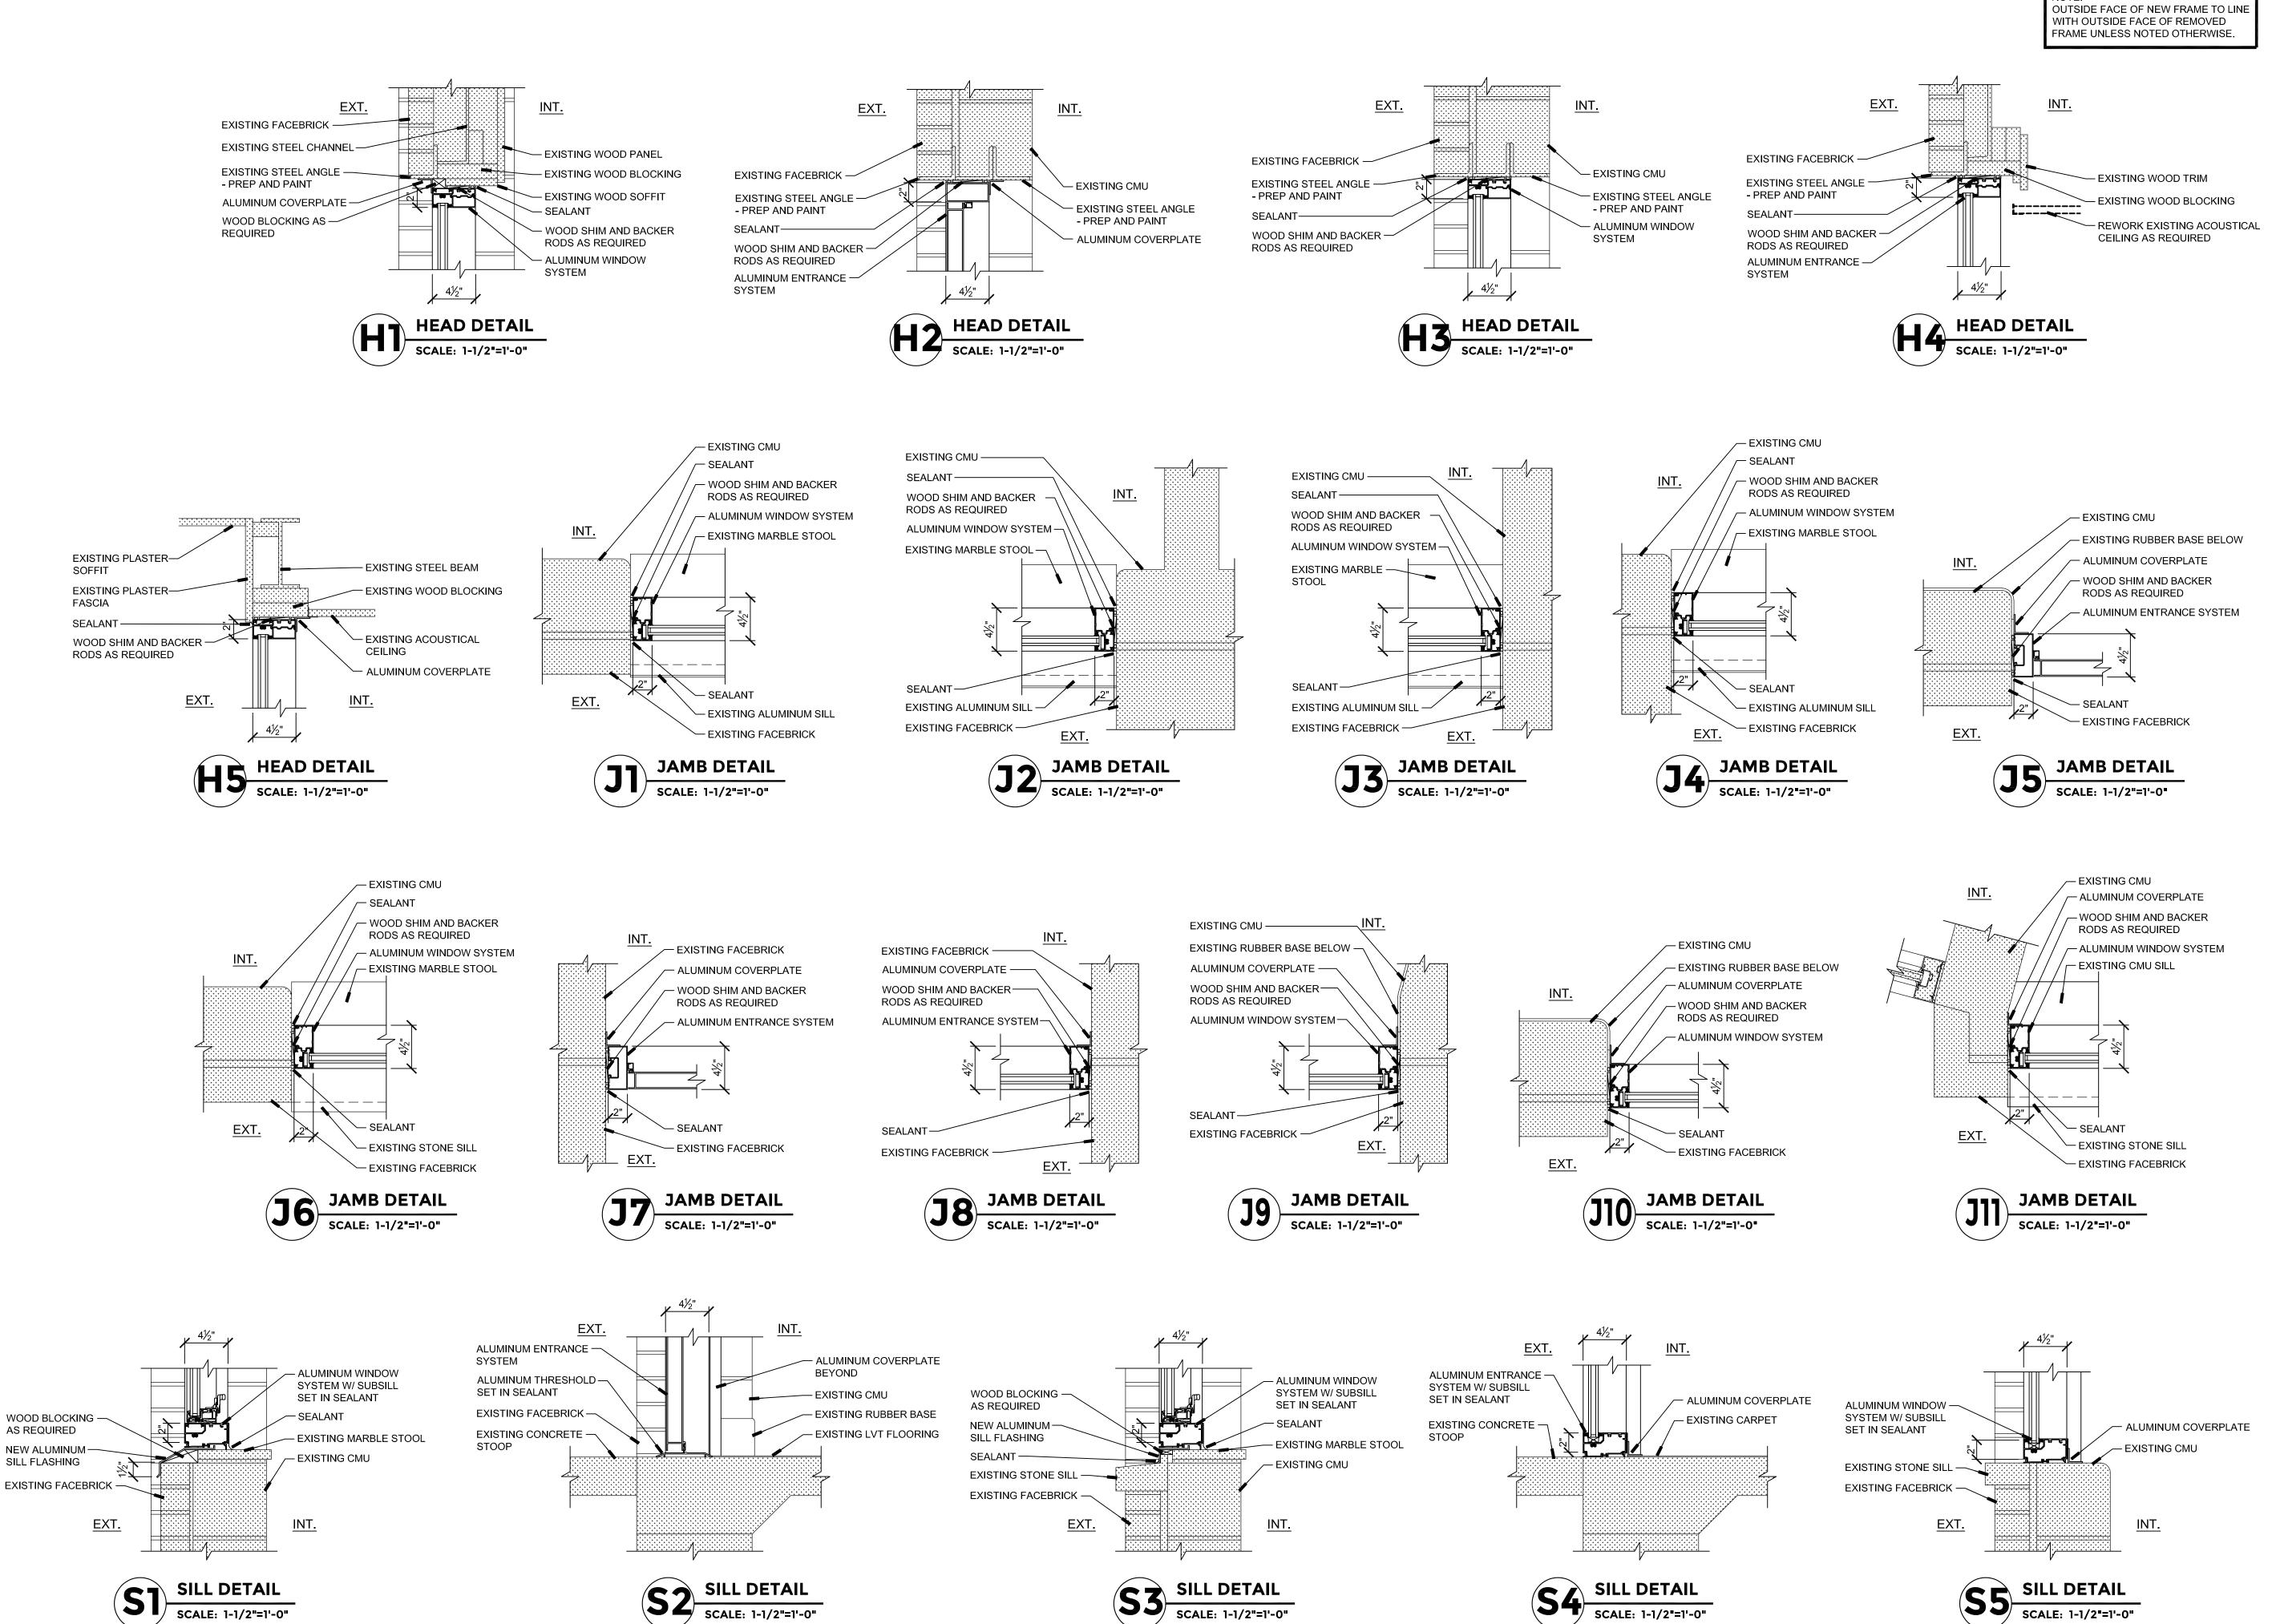

SCALE: 1-1/2"=1'-0"

SCALE: 1-1/2"=1'-0"

**PROJECT** 

# WINDOW REPLACEMENT PROJECT FOR HILLMAN ELEMENTARY

3701 GREEN DALE DRIVE ROCKFORD, ILLINOIS 61109

**OWNER** 

# ROCKFORD PUBLIC SCHOOL DISTRICT 205

501 SEVENTH STREET ROCKFORD, ILLINOIS 61104




ARCHITECT OF RECORD	CIVIL	STRUCTURAL	MECHANICAL / ELECTRICAL / PLUMBING	FOOD SERVICE
RICHARD L. JOHNSON ASSOCIATES 4703 Charles Street Rockford IL. 61108 PHONE: 815/398-1231 FAX 815/398-1280 www.rljarch.com IL. Design Firm No. 187-000524  EXPIRES 11-30-2018  Table 12-1-2018 DATE				
SHEET INDEX	•	•	BID INDEX	STATE MAP
TITLE SHEET  TIO1 TITLE SHEET  ARCHITECTURAL  A101 DEMOLITION PLANS A102 DEMOLITION EXTERIOR ELEVATIONS A103 REVISED PLANS A104 REVISED EXTERIOR ELEVATIONS A105 FRAME TYPES A106 HEAD AND JAMB DETAILS A107 SILL DETAILS			ALTERNATE BID #H1:  PROVIDE NEW DOORS, FRAMES AND HARDWARE AT CLASSROOM 114 AND CLASSROOM 116.  ALTERNATE BID #H2:  PROVIDE ALUMINUM PANEL SYSTEM AT WINDOW TYPES W10 AND W11.	ROCK FORD CHAMPAICK  PEOPL  PE

February 16, 2019


February 18, 2019

SHEET NUMBER

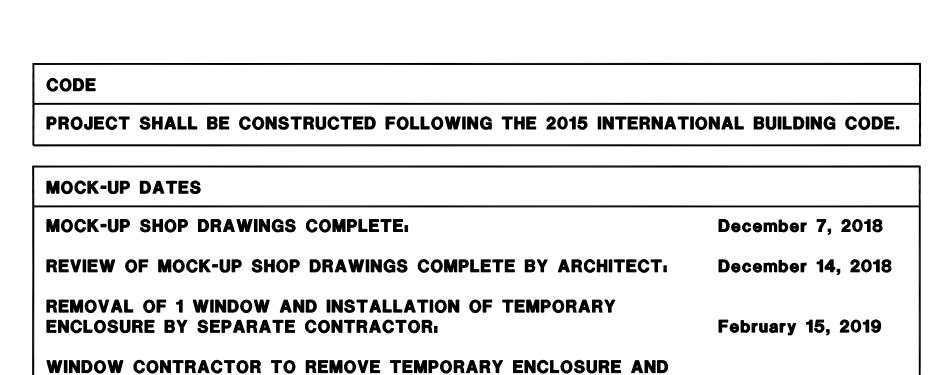

PROJECT START / COMPLETION DATES PROJECT START: June 10, 2019 PROJECT SUBSTANTIALLY COMPLETE: August 26, 2019 FINAL COMPLETION - ALL PUNCH LIST ITEMS: September 3, 2019

**INSTALL WINDOW:** 

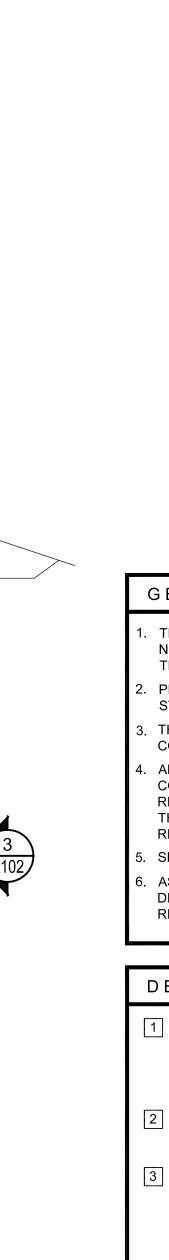

## GENERAL DEMOLITION NOTES

THE DEMOLITION PLAN IS PROVIDED AS AID IN PLANNING AND DOES NOT RELIEVE THE CONTRACTOR'S RESPONSIBILITY IN FIELD VERIFYING THE EXISTING JOB SITE.

**SCALE: NONE** 

- PROVIDE ALL TEMPORARY SHORING AS REQUIRED TO SUPPORT STRUCTURES AND FINISHES TO REMAIN.
- THE CONTRACTOR SHALL COORDINATE ALL FINAL LOCATIONS OF AIR CONDITIONERS WITH THE OWNER / ARCHITECT.
- ANY WALLS OR CEILINGS DAMAGED BY THE ASBESTOS REMOVAL CONTRACTOR SHALL BE REPAIRED AND PAINTED BY THE ASBESTOS REMOVAL CONTRACTOR. ANY WALLS OR CEILINGS DAMAGED DURING THE COURSE OF THE WINDOW INSTALLATION PROJECT SHALL BE REPAIRED AND PAINTED BY THE WINDOW CONTRACTOR.
- SEE DEMOLITION ELEVATIONS FOR ADDITIONAL INFORMATION.
- ASBESTOS CONTRACTOR AND WINDOW CONTRACTOR TO REPORT ANY DETERIORATED LINTELS TO ARCHITECT AND OWNER. OWNER TO REPAIR OR REPLACE AS REQUIRED.

# DEMOLITION BOX NOTES

- 1 ASBESTOS CONTRACTOR HIRED SEPARATELY BY OWNER WILL REMOVE ALUMINUM WINDOW AND CAULKING AND INSTALL PLYWOOD AND FRAMING TO FILL IN THE OPENINGS. WINDOW CONTRACTOR TO REMOVE PLYWOOD AND FRAMING AND TURN OVER TO THE ASBESTOS CONTRACTOR.
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- THE WINDOW CONTRACTOR FOR REINSTALLATION. 5 ASBESTOS CONTRACTOR HIRED SEPARATELY BY OWNER TO
- 6 UNDER ALTERNATE BID #H2: ASBESTOS CONTRACTOR HIRED SEPARATELY BY OWNER TO REMOVE EXISTING LOUVER.

REMOVE EXISTING WINDOW TREATMENT.

- 7 UNDER ALTERNATE BID #H2: ASBESTOS CONTRACTOR HIRED SEPARATELY BY OWNER WILL REMOVE ALUMINUM WINDOW AND CAULKING AND INSTALL PLYWOOD AND FRAMING TO FILL IN THE OPENINGS. WINDOW CONTRACTOR TO REMOVE PLYWOOD AND FRAMING AND TURN OVER TO THE ASBESTOS CONTRACTOR.
- 8 UNDER ALTERNATE BID #H2: ASBESTOS CONTRACTOR HIRED SEPARATELY BY OWNER WILL REMOVE ALUMINUM
- **SECOND FLOOR DEMOLITION PLAN** COVERPLATES/TUBES. 9 EXISTING ALUMINUM COVERPLATES/TUBES TO REMAIN.


SCALE: 1"=20'-0"

5TH GRADE

2ND GRADE 5

BILINGUAL 1


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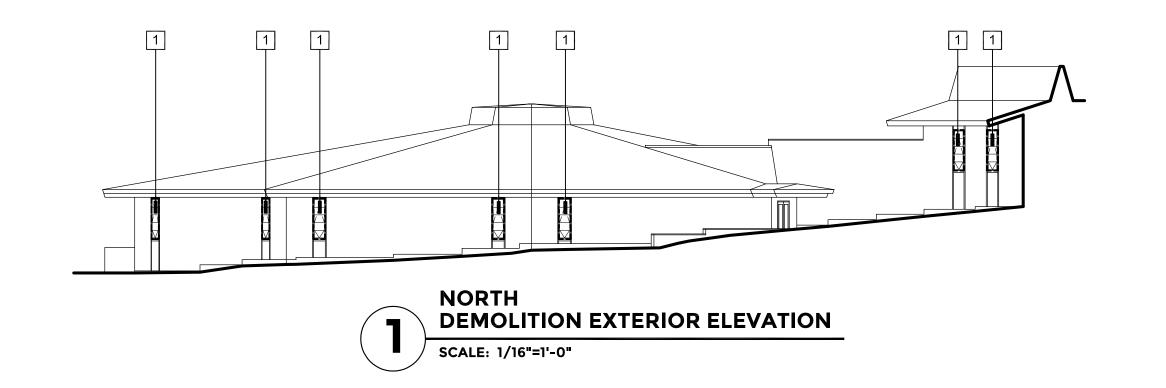


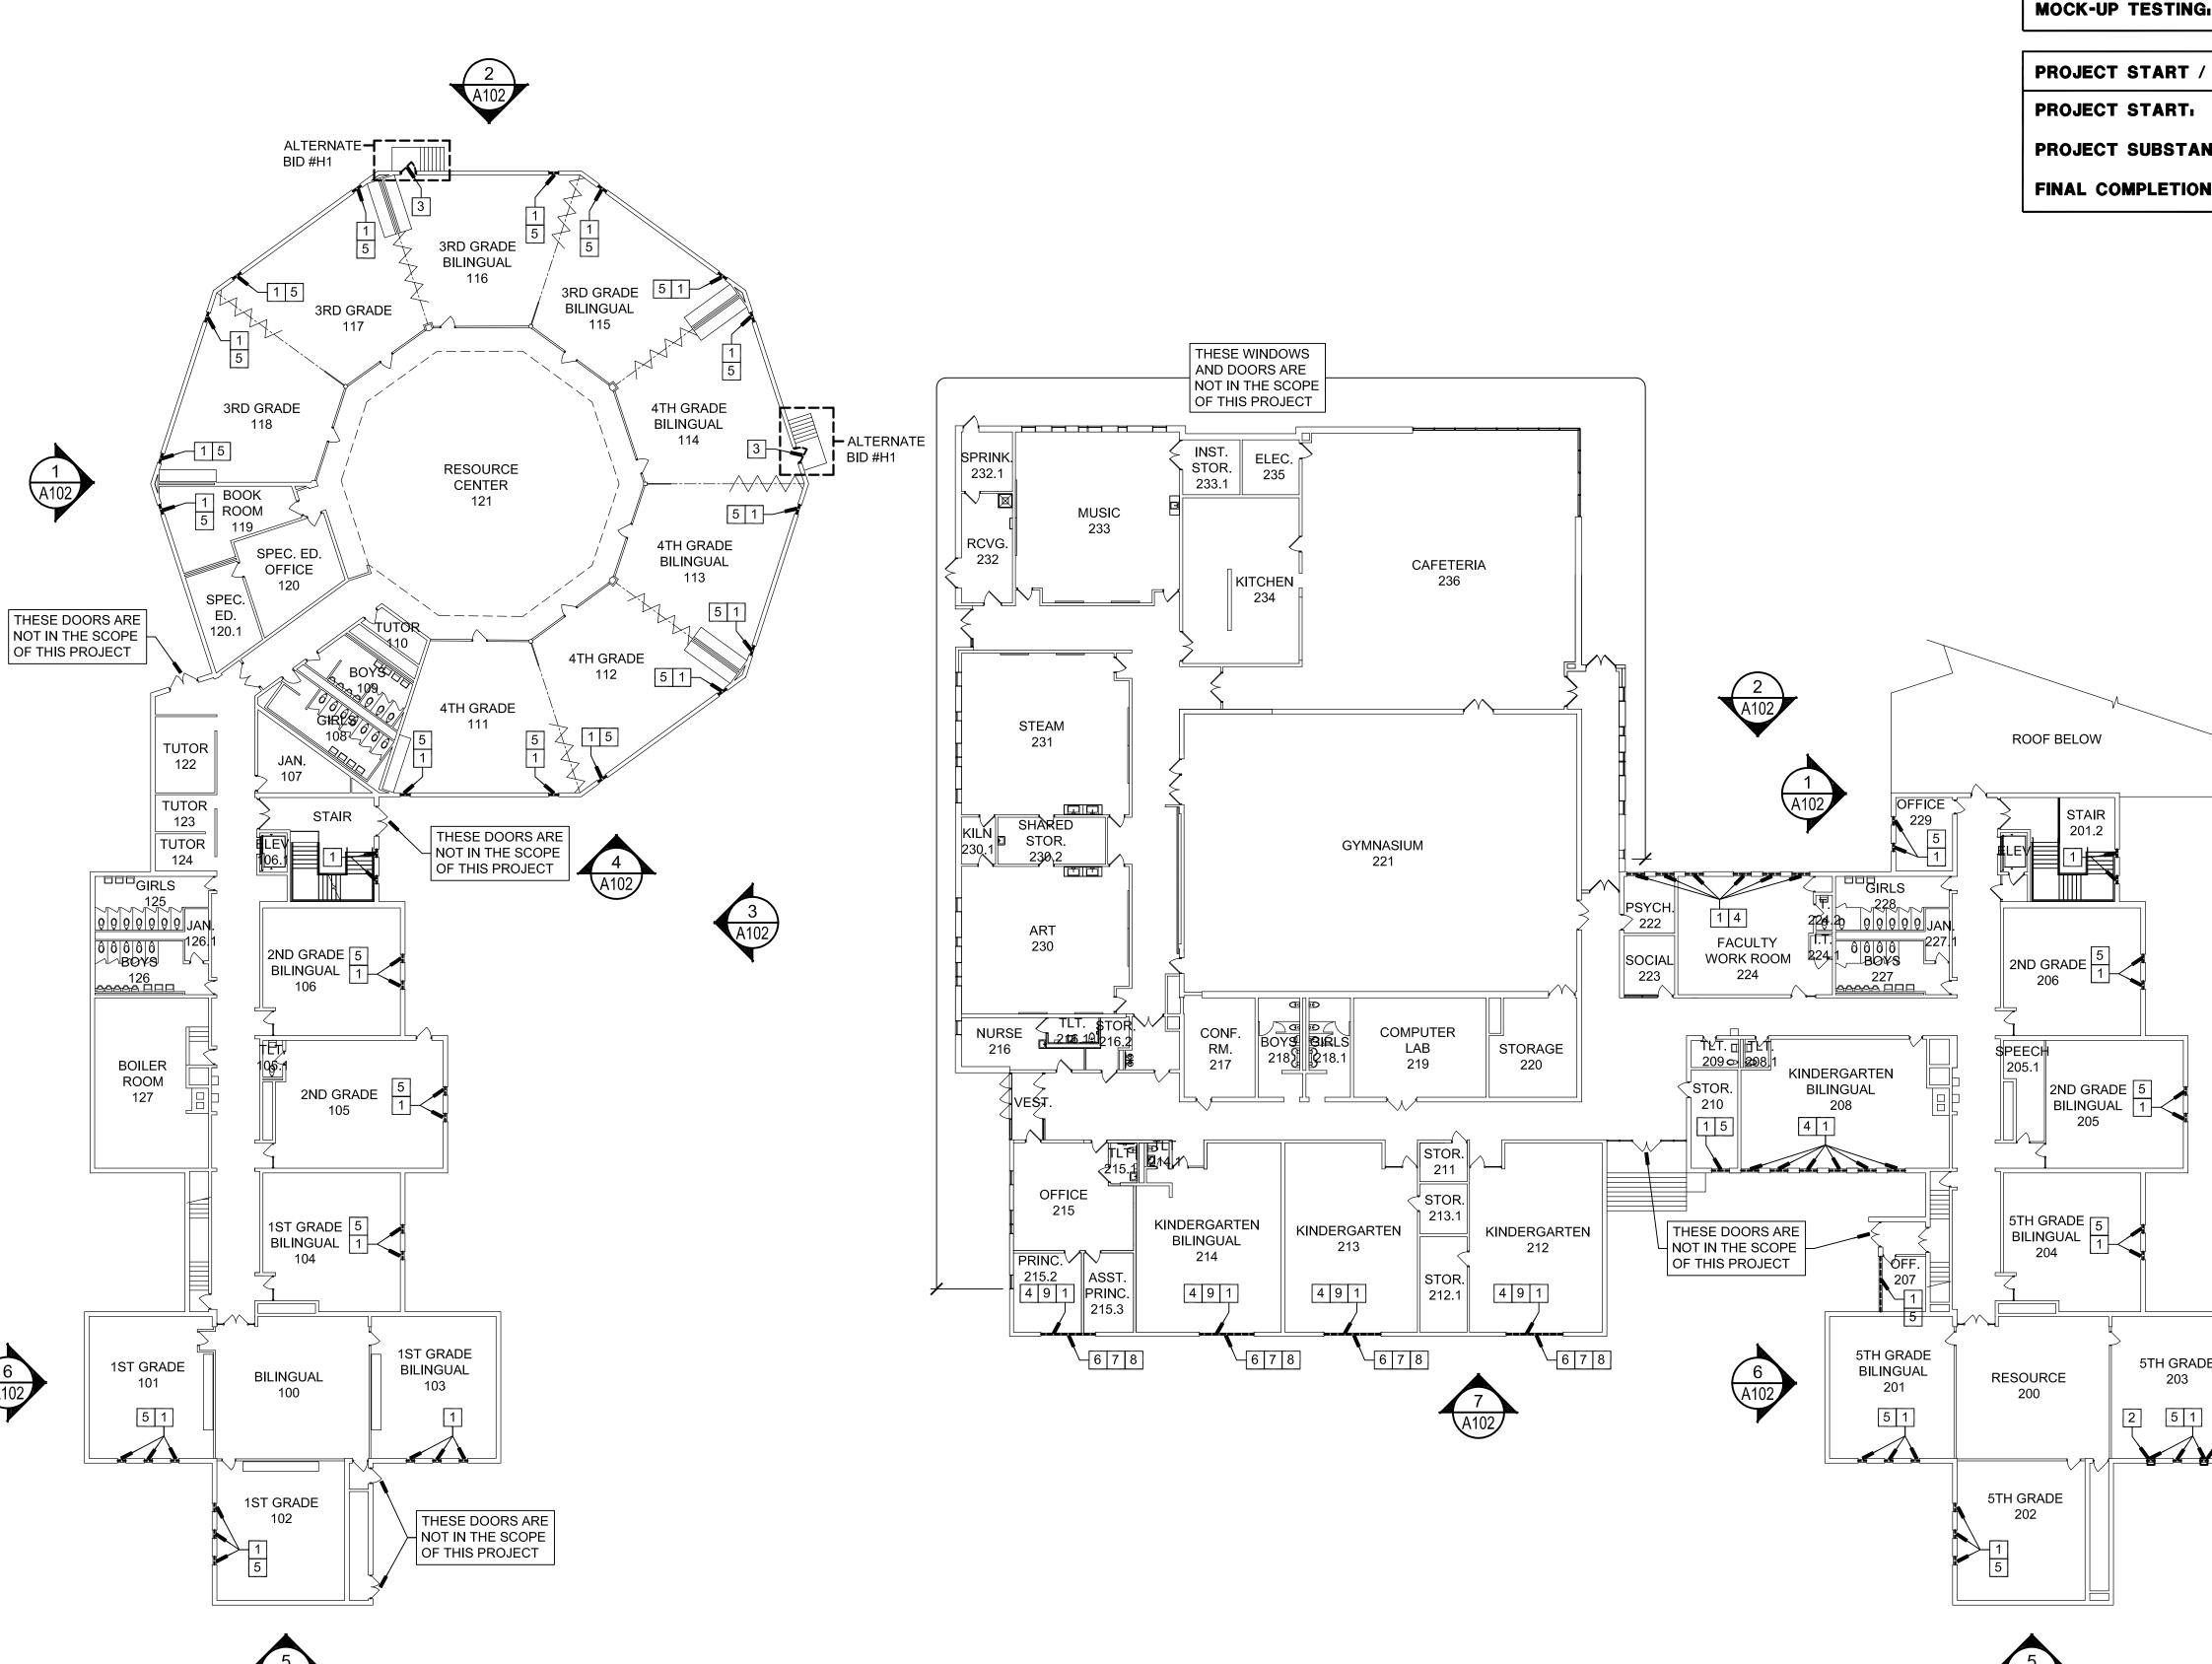
FIRST FLOOR DEMOLITION PLAN


SCALE: 1"=20'-0"

A102




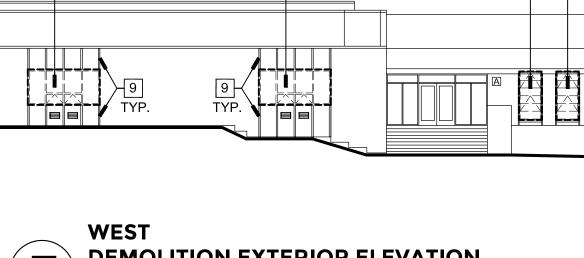


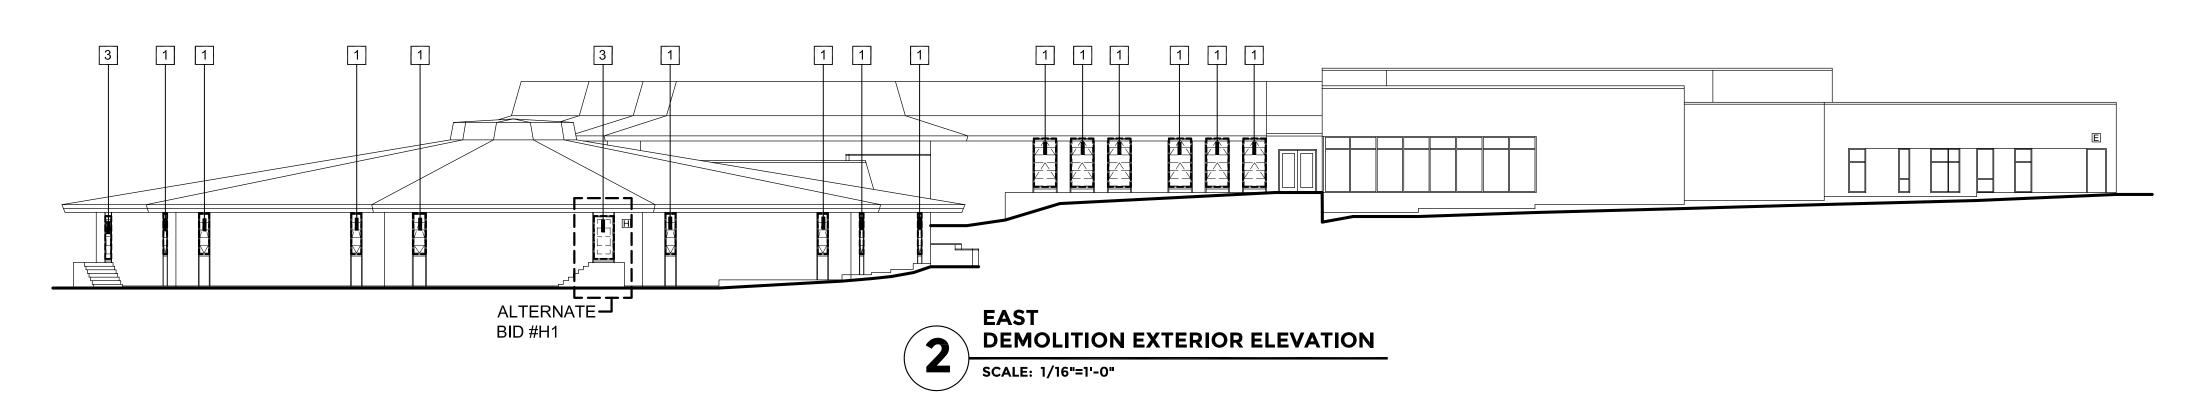


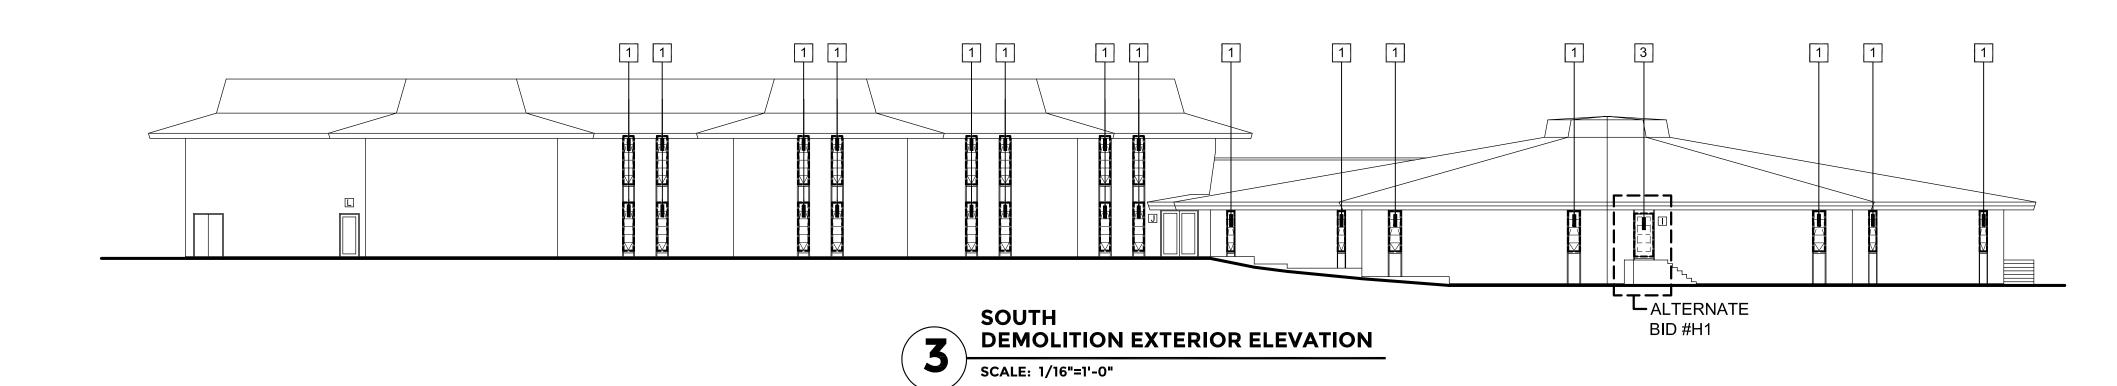

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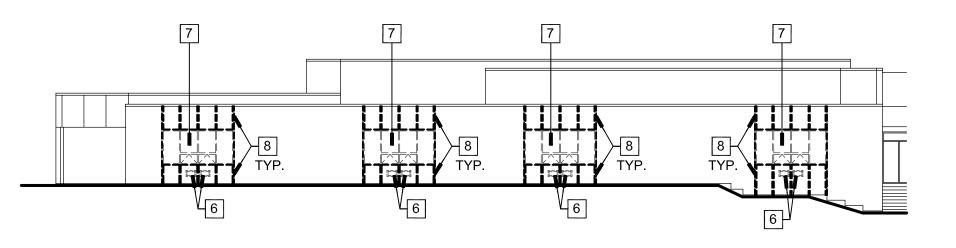


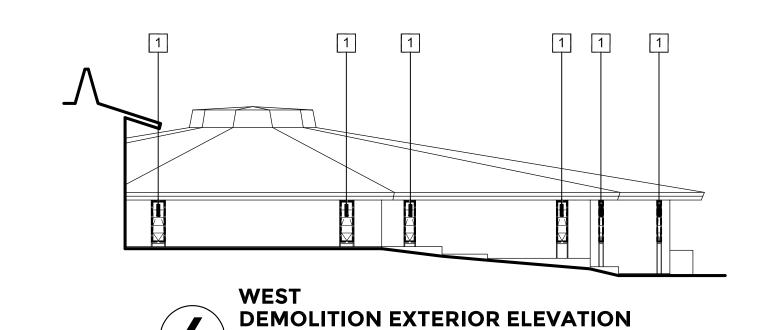

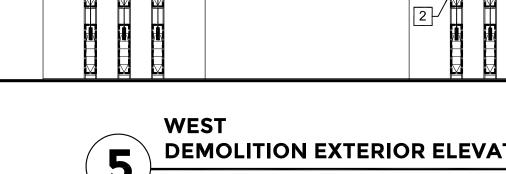

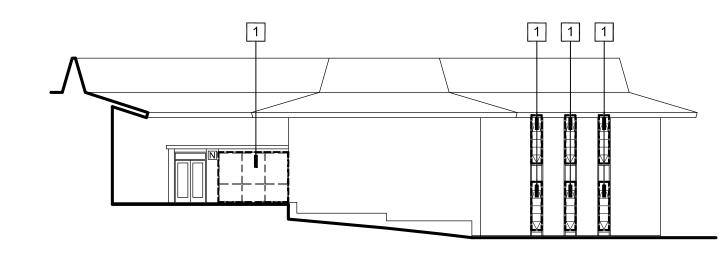







SCALE: 1/16"=1'-0"





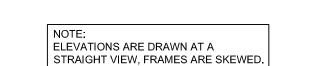

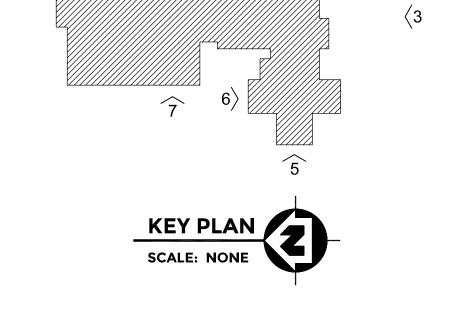


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- 9 EXISTING ALUMINUM COVERPLATES/TUBES TO REMAIN.

A103



ALTERNATE | DOOR H101
BID #H1

3RD GRADE 117

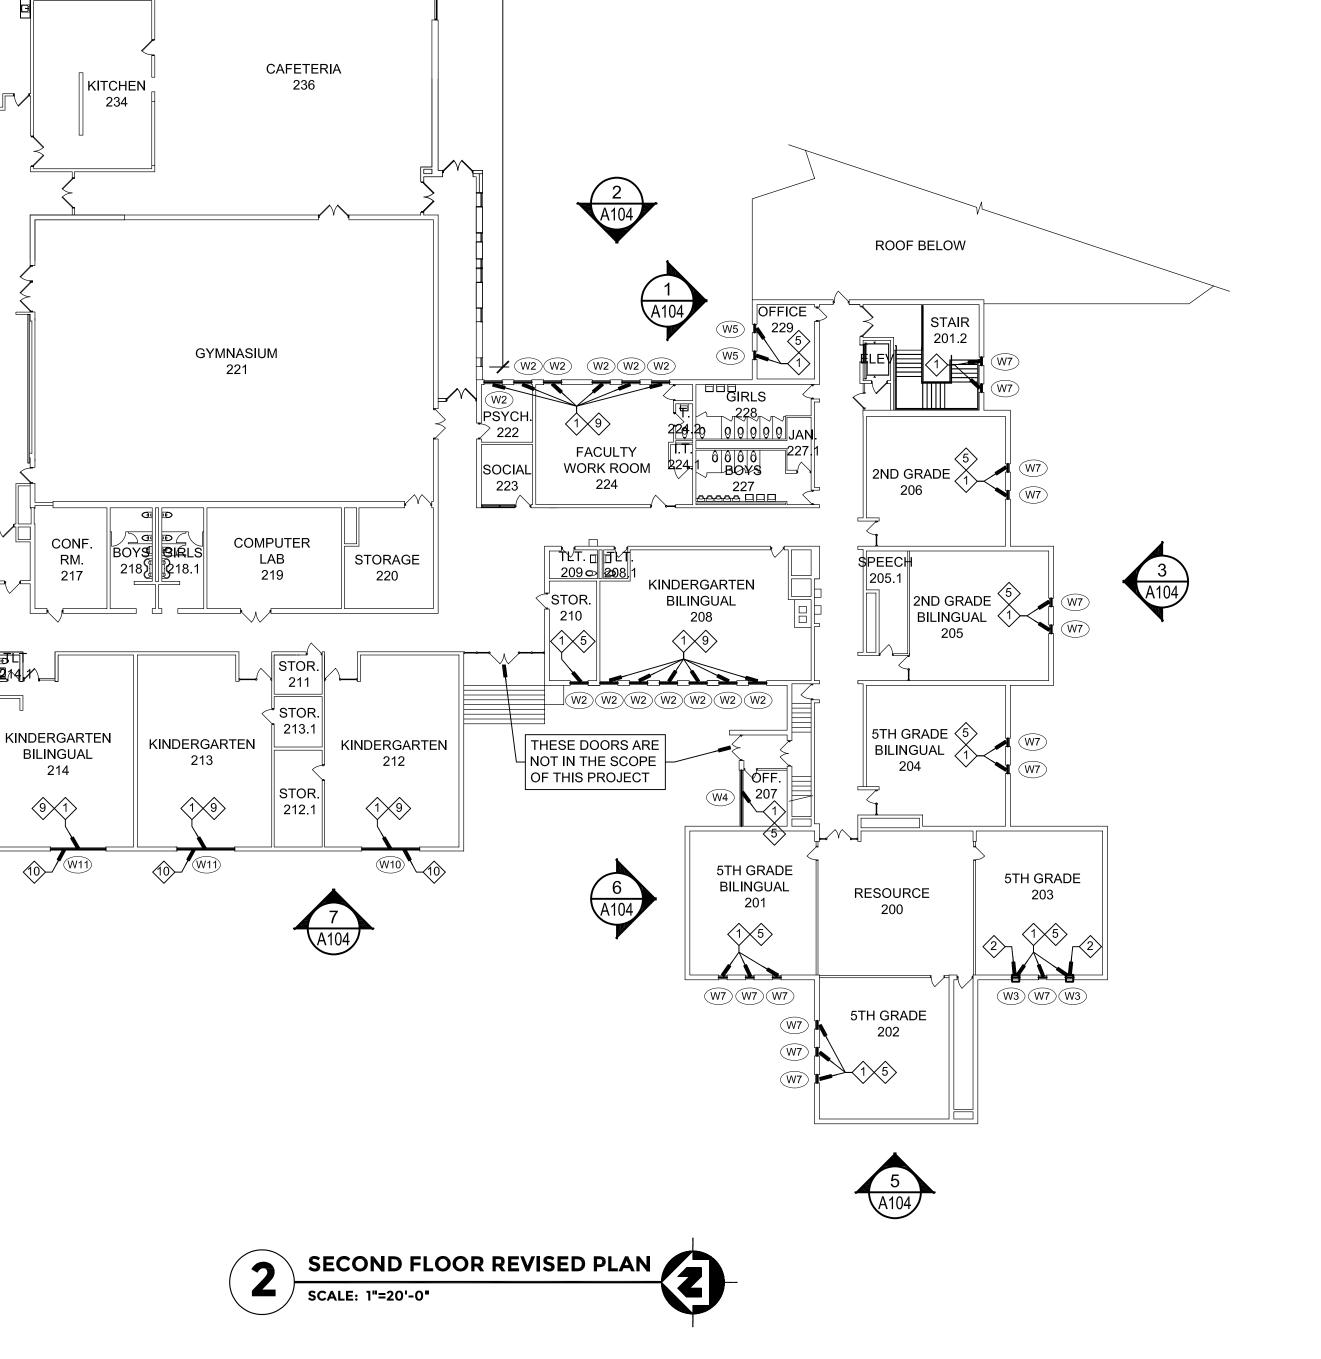 $1\sqrt{5}$ 

BOOK ROOM

SPEC. ED. \ 120.1

122

TUTOR 123

TUTOR

124

GIRLS

125

|<u>|9|9|9|9|9|</u>JAN

00000 BOYS 126.1

126 <del>\_\_\_\_\_</del>

BOILER

ROOM

127

1ST GRADE

W6 W6 W6

1 A104

THESE DOORS ARE NOT IN THE SCOPE

OF THIS PROJECT

3RD GRADE

OFFICE

120

JAN. 107

2ND GRADE \$\frac{5}{2}

BILINGUAL (1)

1ST GRADE \$\frac{5}{2}

1ST GRADE

BILINGUAL

W6 W6 W6

FIRST FLOOR REVISED PLAN

THESE DOORS ARE

NOT IN THE SCOPE

OF THIS PROJECT

BILINGUAL <

BILINGUAL

1ST GRADE

3RD GRADE BILINGUAL

RESOURCE CENTER

4TH GRADE 111

THESE DOORS ARE

 $\dashv$  NOT IN THE SCOPE

OF THIS PROJECT

3RD GRADE 5 1 BILINGUAL

4TH GRADE

4TH GRADE BILINGUAL

4TH GRADE 5

BILINGUAL

113

DOOR H102

SPRINK. 232.1

RCVG.

232

STEAM

STOR.

230

OFFICE

215

PRINC.

PRINC.

215.3

215.2

NURSE

216

THESE WINDOWS
AND DOORS ARE NOT IN THE SCOPE OF THIS PROJECT


ELEC. 235

STOR.

233.1

CONF. RM. 217

MUSIC 233

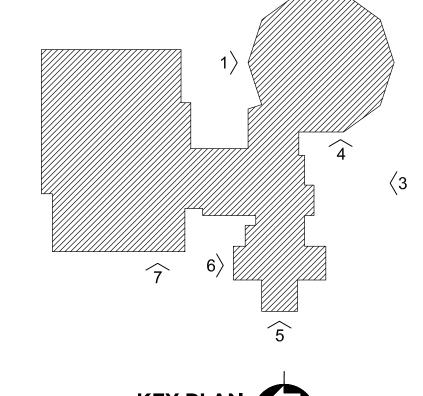

## GENERAL NOTES

- THE CONTRACTOR SHALL VERIFY ALL EXISTING WINDOW DIMENSIONS
- PROVIDE BACKER ROD AND SEALANT AROUND PERIMETER OF NEW
- CONTRACTOR IS RESPONSIBLE FOR ADDING STRUCTURAL REINFORCEMENT AS REQUIRED TO MEET STRUCTURAL LOADING
- FOR ALL WINDOW TYPES. WINDOWS SHALL OPEN AS FAR AS POSSIBLE. AT END OF PROJECT THE OWNER/ARCHITECT SHALL DETERMINE WHICH OPERABLE WINDOWS WILL REQUIRE A 4" MAXIMUM OPENING. CONTRACTOR TO ADJUST OPENING AS REQUIRED.
- PROVIDE A PROPER CAULK JOINT BETWEEN A/C UNITS AND METAL
- PROVIDE TREATED WOOD SHIMS AND BLOCKING AS REQUIRED FOR WINDOW INSTALLATIONS. APPLY A COATING TO THE WOOD BLOCKING SO AS TO NOT CHEMICALLY REACT WITH THE ALUMINUM.
- CONTRACTOR TO RESTORE ANY DISTURBED GRASS AREAS WITH SEED BACK TO ORIGINAL CONDITIONS AFTER WORK IS COMPLETE.
- CONTRACTOR TO VERIFY EXACT LOCATIONS AND SIZES OF AIR
- CONDITIONER UNITS IN NEW WINDOW SYSTEM WITH OWNER/ARCHITECT LINTELS AT WINDOWS TO BE PAINTED THE SAME COLOR AS WINDOWS.
- . CONTRACTOR TO PROVIDE INTERIOR METAL TRIM AT FLOORS, WALLS AND CEILINGS AS REQUIRED TO COVER ANY EXPOSED CONSTRUCTION WHETHER SHOWN ON DETAILS OR NOT.
- . INSULATED METAL PANEL COLOR TO MATCH WINDOW FRAMING COLOR. VERIFY COLOR WITH OWNER.
- 12. CAULK COLOR TO MATCH WINDOW FRAMING COLOR.
- WINDOW CONTRACTOR SHALL BE RESPONSIBLE FOR THE FINAL CLEANING OF THE NEW WINDOWS ON THE EXTERIOR AND THE
- . DIMENSIONS SHOWN ARE TAKEN FROM EXISTING INTERIOR JAMB TO EXISTING INTERIOR JAMB, AND FROM EXISTING INTERIOR SILL TO EXISTING INTERIOR HEAD.
- 5. OUTSIDE FACE OF NEW FRAME TO LINE WITH OUTSIDE FACE OF EXISTING FRAME UNLESS NOTED OTHERWISE.

## RENOVATION KEY NOTES

- WINDOW CONTRACTOR TO INSTALL NEW ALUMINUM WINDOW SYSTEM AND GLAZING COMPLETE.
- 2 WINDOW CONTRACTOR TO INSTALL EXISTING AIR CONDITIONER IN NEW INSULATED METAL PANEL (GL-2). REINSTALL EXISTING A/C SUPPORTS. INSTALL SEALANT BETWEEN THE PANEL AND THE A/C UNIT TO MATCH
- (3) UNDER ALTERNATE BID #H1: WINDOW CONTRACTOR TO INSTALL NEW ALUMINUM DOOR, FRAME, HARDWARE AND GLAZING COMPLETE.
- 4 THIS WINDOW TO BE A MOCK-UP WINDOW. SEE SPECIFICATIONS. (5) WINDOW CONTRACTOR TO INSTALL NEW SHADE. SEE SPECIFICATIONS.
- 6 UNDER ALTERNATE BID #H2: WINDOW CONTRACTOR TO INSTALL NEW CLEAR ANODIZED ALUMINUM LOUVER. MATCH EXISTING SIZE - V.I.F.
- (7) UNDER ALTERNATE BID #2: INSTALL NEW ALUMINUM PANEL SYSTEM.
- (8) UNDER ALTERNATE BID #2: ALUMINUM PANEL REVEAL.

EXTEND DUCTWORK AS REQUIRED.

- (9) WINDOW CONTRACTOR TO REINSTALL SALVAGED SHADE.
- UNDER ALTERNATE BID H2: WINDOW CONTRACTOR TO INSTALL NEW ALUMINUM WINDOW SYSTEM AND GLAZING COMPLETE.

2

7

SCALE: NONE

THE CONTRACTOR SHALL VERIFY ALL EXISTING WINDOW DIMENSIONS

PRIOR TO BIDDING. THE DIMENSIONS ON THE DRAWING ARE +/-. PROVIDE BACKER ROD AND SEALANT AROUND PERIMETER OF NEW

WINDOWS SHALL OPEN AS FAR AS POSSIBLE. AT END OF PROJECT THE OWNER/ARCHITECT SHALL DETERMINE WHICH OPERABLE WINDOWS WILL REQUIRE A 4" MAXIMUM OPENING. CONTRACTOR

PROVIDE A PROPER CAULK JOINT BETWEEN A/C UNITS AND METAL

PROVIDE TREATED WOOD SHIMS AND BLOCKING AS REQUIRED

FOR WINDOW INSTALLATIONS. APPLY A COATING TO THE WOOD

CONTRACTOR TO RESTORE ANY DISTURBED GRASS AREAS WITH SEED BACK TO ORIGINAL CONDITIONS AFTER WORK IS COMPLETE.

CONDITIONER UNITS IN NEW WINDOW SYSTEM WITH OWNER/ARCHITECT. LINTELS AT WINDOWS TO BE PAINTED THE SAME COLOR AS WINDOWS. . CONTRACTOR TO PROVIDE INTERIOR METAL TRIM AT FLOORS, WALLS AND CEILINGS AS REQUIRED TO COVER ANY EXPOSED CONSTRUCTION

CONTRACTOR TO VERIFY EXACT LOCATIONS AND SIZES OF AIR

. INSULATED METAL PANEL COLOR TO MATCH WINDOW FRAMING

3. WINDOW CONTRACTOR SHALL BE RESPONSIBLE FOR THE FINAL CLEANING OF THE NEW WINDOWS ON THE EXTERIOR AND THE

DIMENSIONS SHOWN ARE TAKEN FROM EXISTING INTERIOR JAMB TO

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UNDER ALTERNATE BID #H2: WINDOW CONTRACTOR TO INSTALL NEW CLEAR ANODIZED ALUMINUM LOUVER. MATCH EXISTING SIZE - V.I.F.

7 UNDER ALTERNATE BID #2: INSTALL NEW ALUMINUM PANEL SYSTEM.

10 UNDER ALTERNATE BID H2: WINDOW CONTRACTOR TO INSTALL NEW

4 THIS WINDOW TO BE A MOCK-UP WINDOW. SEE SPECIFICATIONS.

5. OUTSIDE FACE OF NEW FRAME TO LINE WITH OUTSIDE FACE OF

BLOCKING SO AS TO NOT CHEMICALLY REACT WITH THE

WINDOW AND ENTRANCE FRAMES - EACH SIDE OF FRAMES. CONTRACTOR IS RESPONSIBLE FOR ADDING STRUCTURAL REINFORCEMENT AS REQUIRED TO MEET STRUCTURAL LOADING

GENERAL NOTES

FOR ALL WINDOW TYPES.

PANELS.

ALUMINUM.

INTERIOR.

PANEL COLOR.

ELEVATIONS ARE DRAWN AT A STRAIGHT VIEW, FRAMES ARE SKEWED. TO ADJUST OPENING AS REQUIRED.

WHETHER SHOWN ON DETAILS OR NOT.

COLOR. VERIFY COLOR WITH OWNER.

EXISTING INTERIOR HEAD.

12. CAULK COLOR TO MATCH WINDOW FRAMING COLOR.

EXISTING FRAME UNLESS NOTED OTHERWISE.

RENOVATION KEY NOTES

EXTEND DUCTWORK AS REQUIRED.


8 UNDER ALTERNATE BID #2: ALUMINUM PANEL REVEAL.

9 WINDOW CONTRACTOR TO REINSTALL SALVAGED SHADE.

ALUMINUM WINDOW SYSTEM AND GLAZING COMPLETE.

SHEET NUMBER

A104

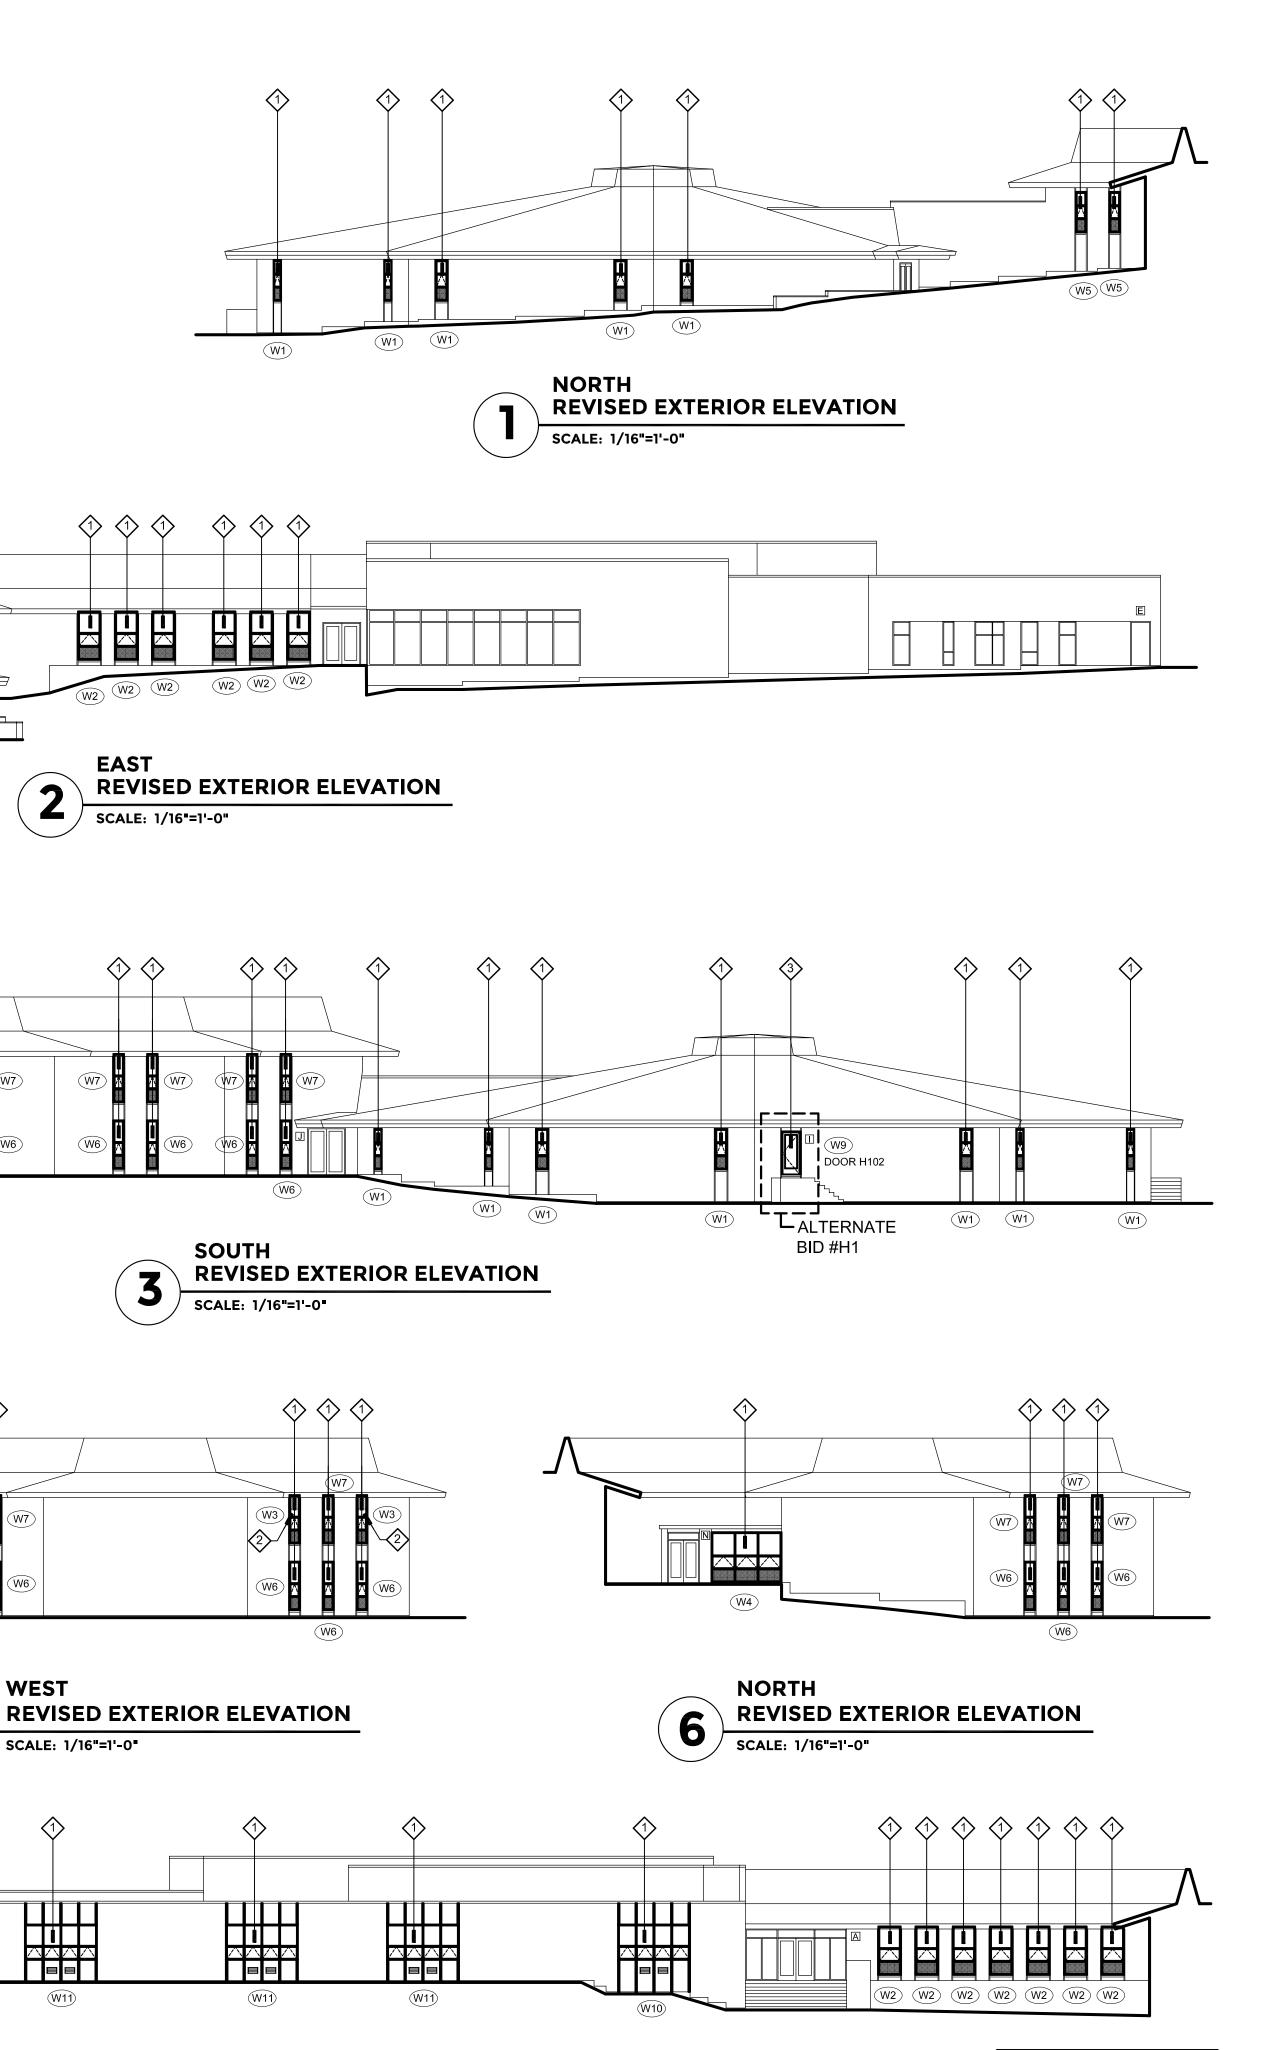

**WEST** 

SCALE: 1/16"=1'-0"

**REVISED EXTERIOR ELEVATION** 

ALTERNATE W1

BID #H1

 $\Diamond$ 

W1) W1)

TYP. 6

W1

TYP. <8>

**ALTERNATE BID #H2** 

REVISED EXTERIOR ELEVATION

SCALE: 1/16"=1'-0"

TYP. 7

**WEST** 

TYP. (6)

W1

**REVISED EXTERIOR ELEVATION** 

 $\diamondsuit \diamondsuit \diamondsuit$ 

**WEST** 

W11


W9 W1 W1

A105

THE CONTRACTOR SHALL VERIFY ALL EXISTING WINDOW DIMENSIONS

GENERAL NOTES

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- 15. OUTSIDE FACE OF NEW FRAME TO LINE WITH OUTSIDE FACE OF EXISTING FRAME UNLESS NOTED OTHERWISE.

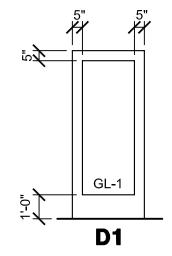

SCALE: 1/4"=1'-0"

DOOR TYPES


GLASS TYPES


GL-1 1" INSULATED TEMPERED GLASS


1" INSULATED OBSCURE TEMPERED GLASS


GL-2 1" INSULATED METAL PANEL


DOC	DOOR SCHEDULE											
DOOR	DOORS			DOOR TYPE		FRAMES						
DOOR NO.	SG/PR	WIDTH	HEIGHT	THICK	MTL	ELEV.	MTL	ELEV.	DOOR GLAZING	HDWR GROUP	LABEL	REMARKS
H101	SG	3'-0"	7'-0"	2"	AL	D1	AL	W8	GL-1	01	NONE	-
H102	SG	3'-0"	7'-0"	2"	AL	D1	AL	W9	GL-1	01	NONE	-

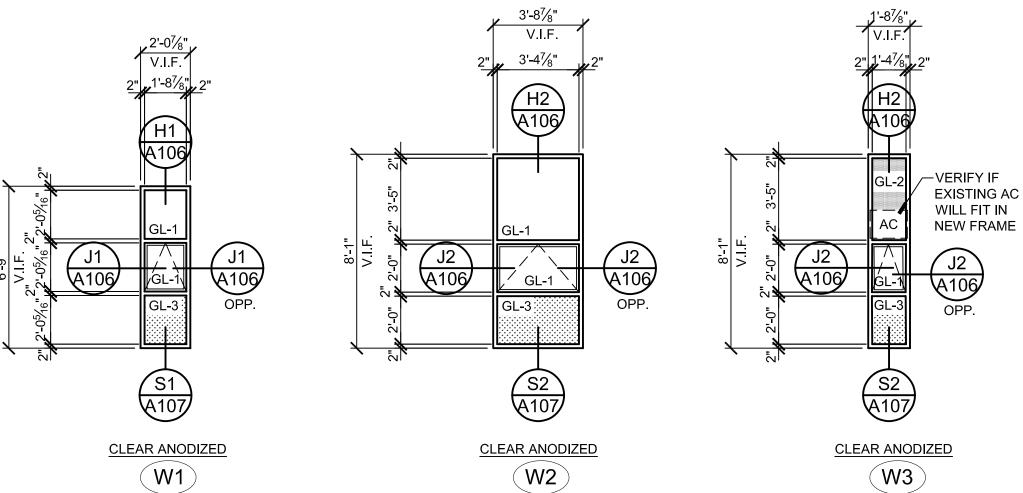


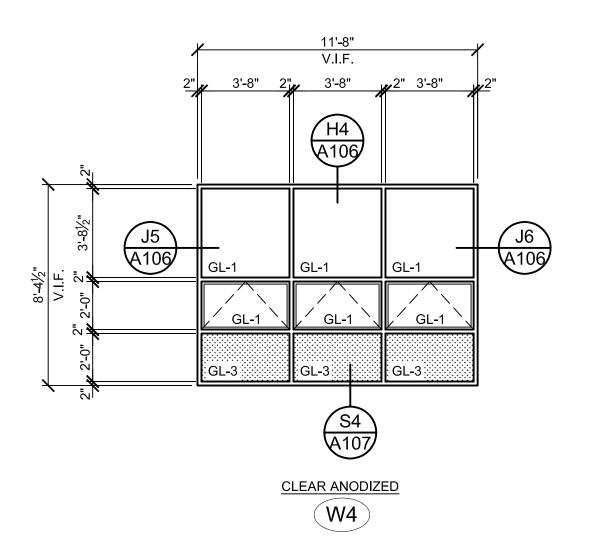


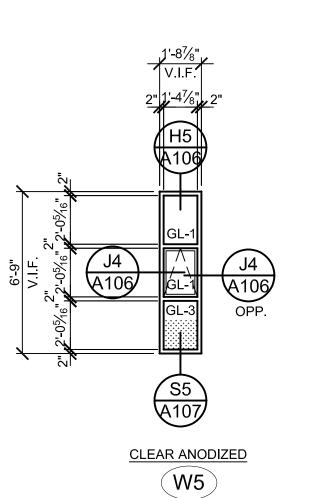

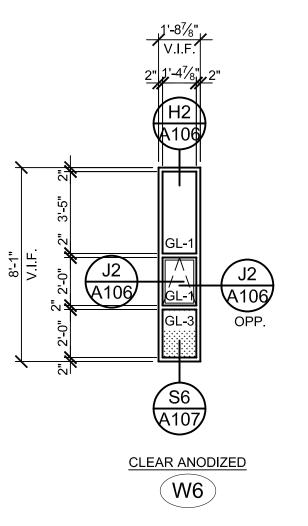


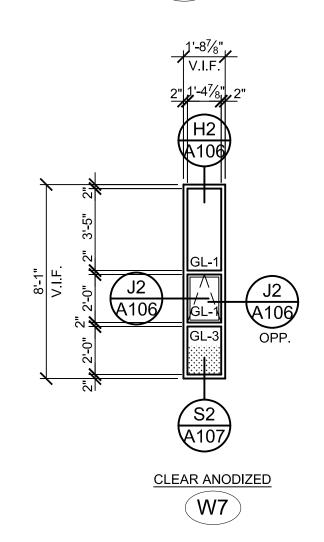

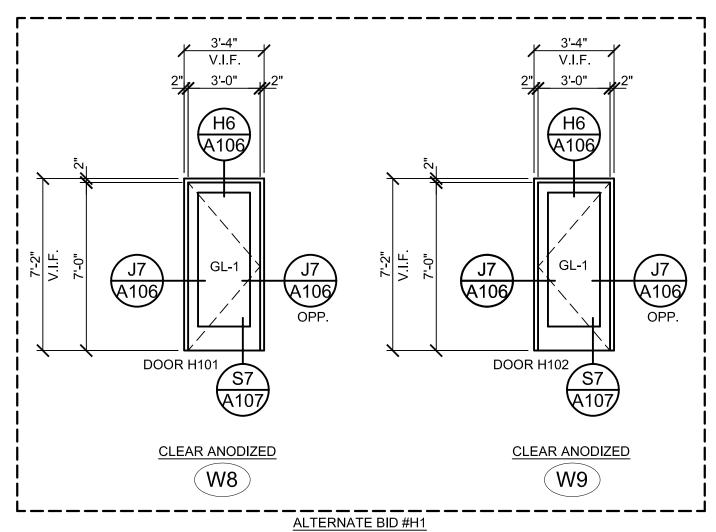


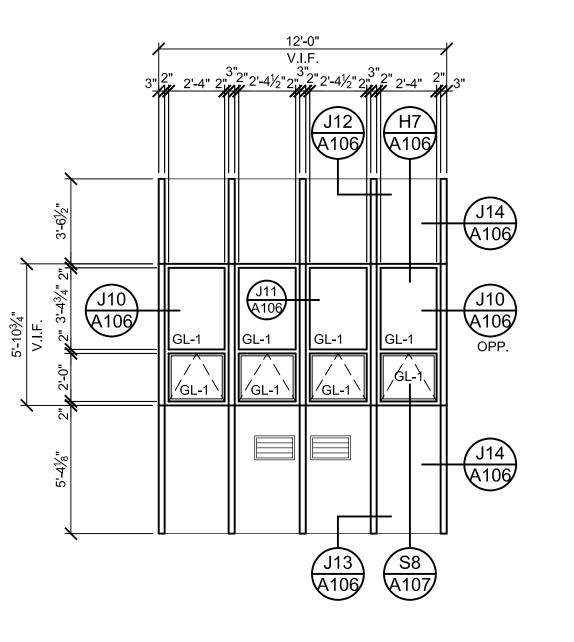


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0 ~ **DISTRICT** SCHOOL SCHOOL PUBLIC ROCKFORD, ILLINOIS

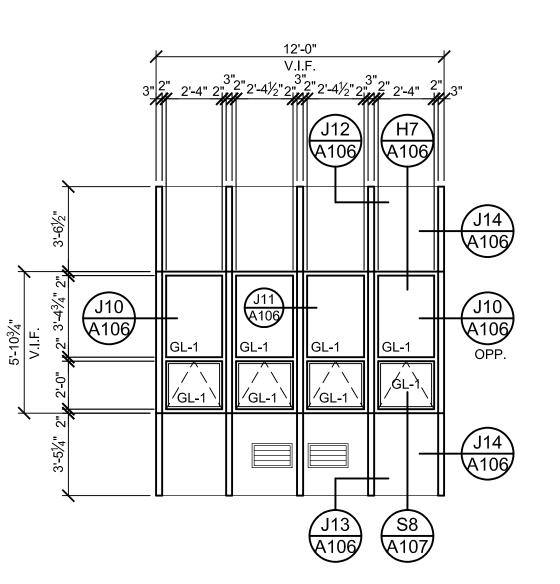JOHNSON RCHITECTS 7 RICHAR ASSOCIA

SHEET NUMBER A106

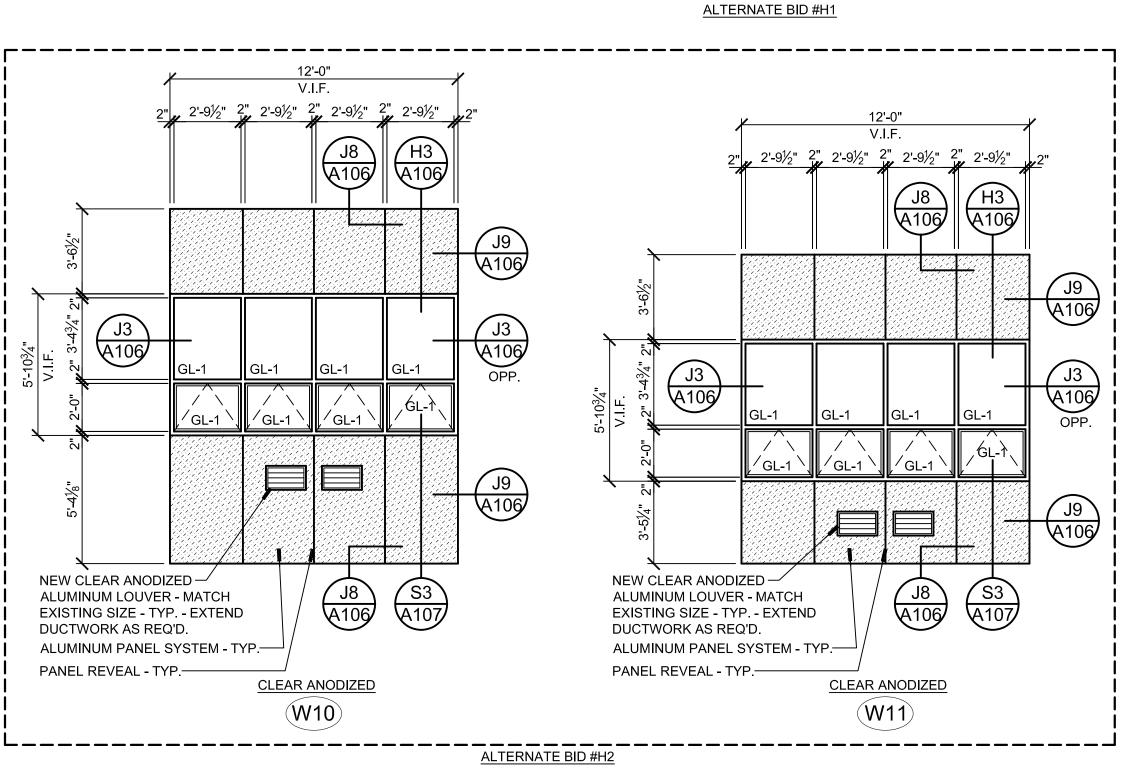TYPICAL NOTE: OUTSIDE FACE OF NEW FRAME TO LINE WITH OUTSIDE FACE OF REMOVED

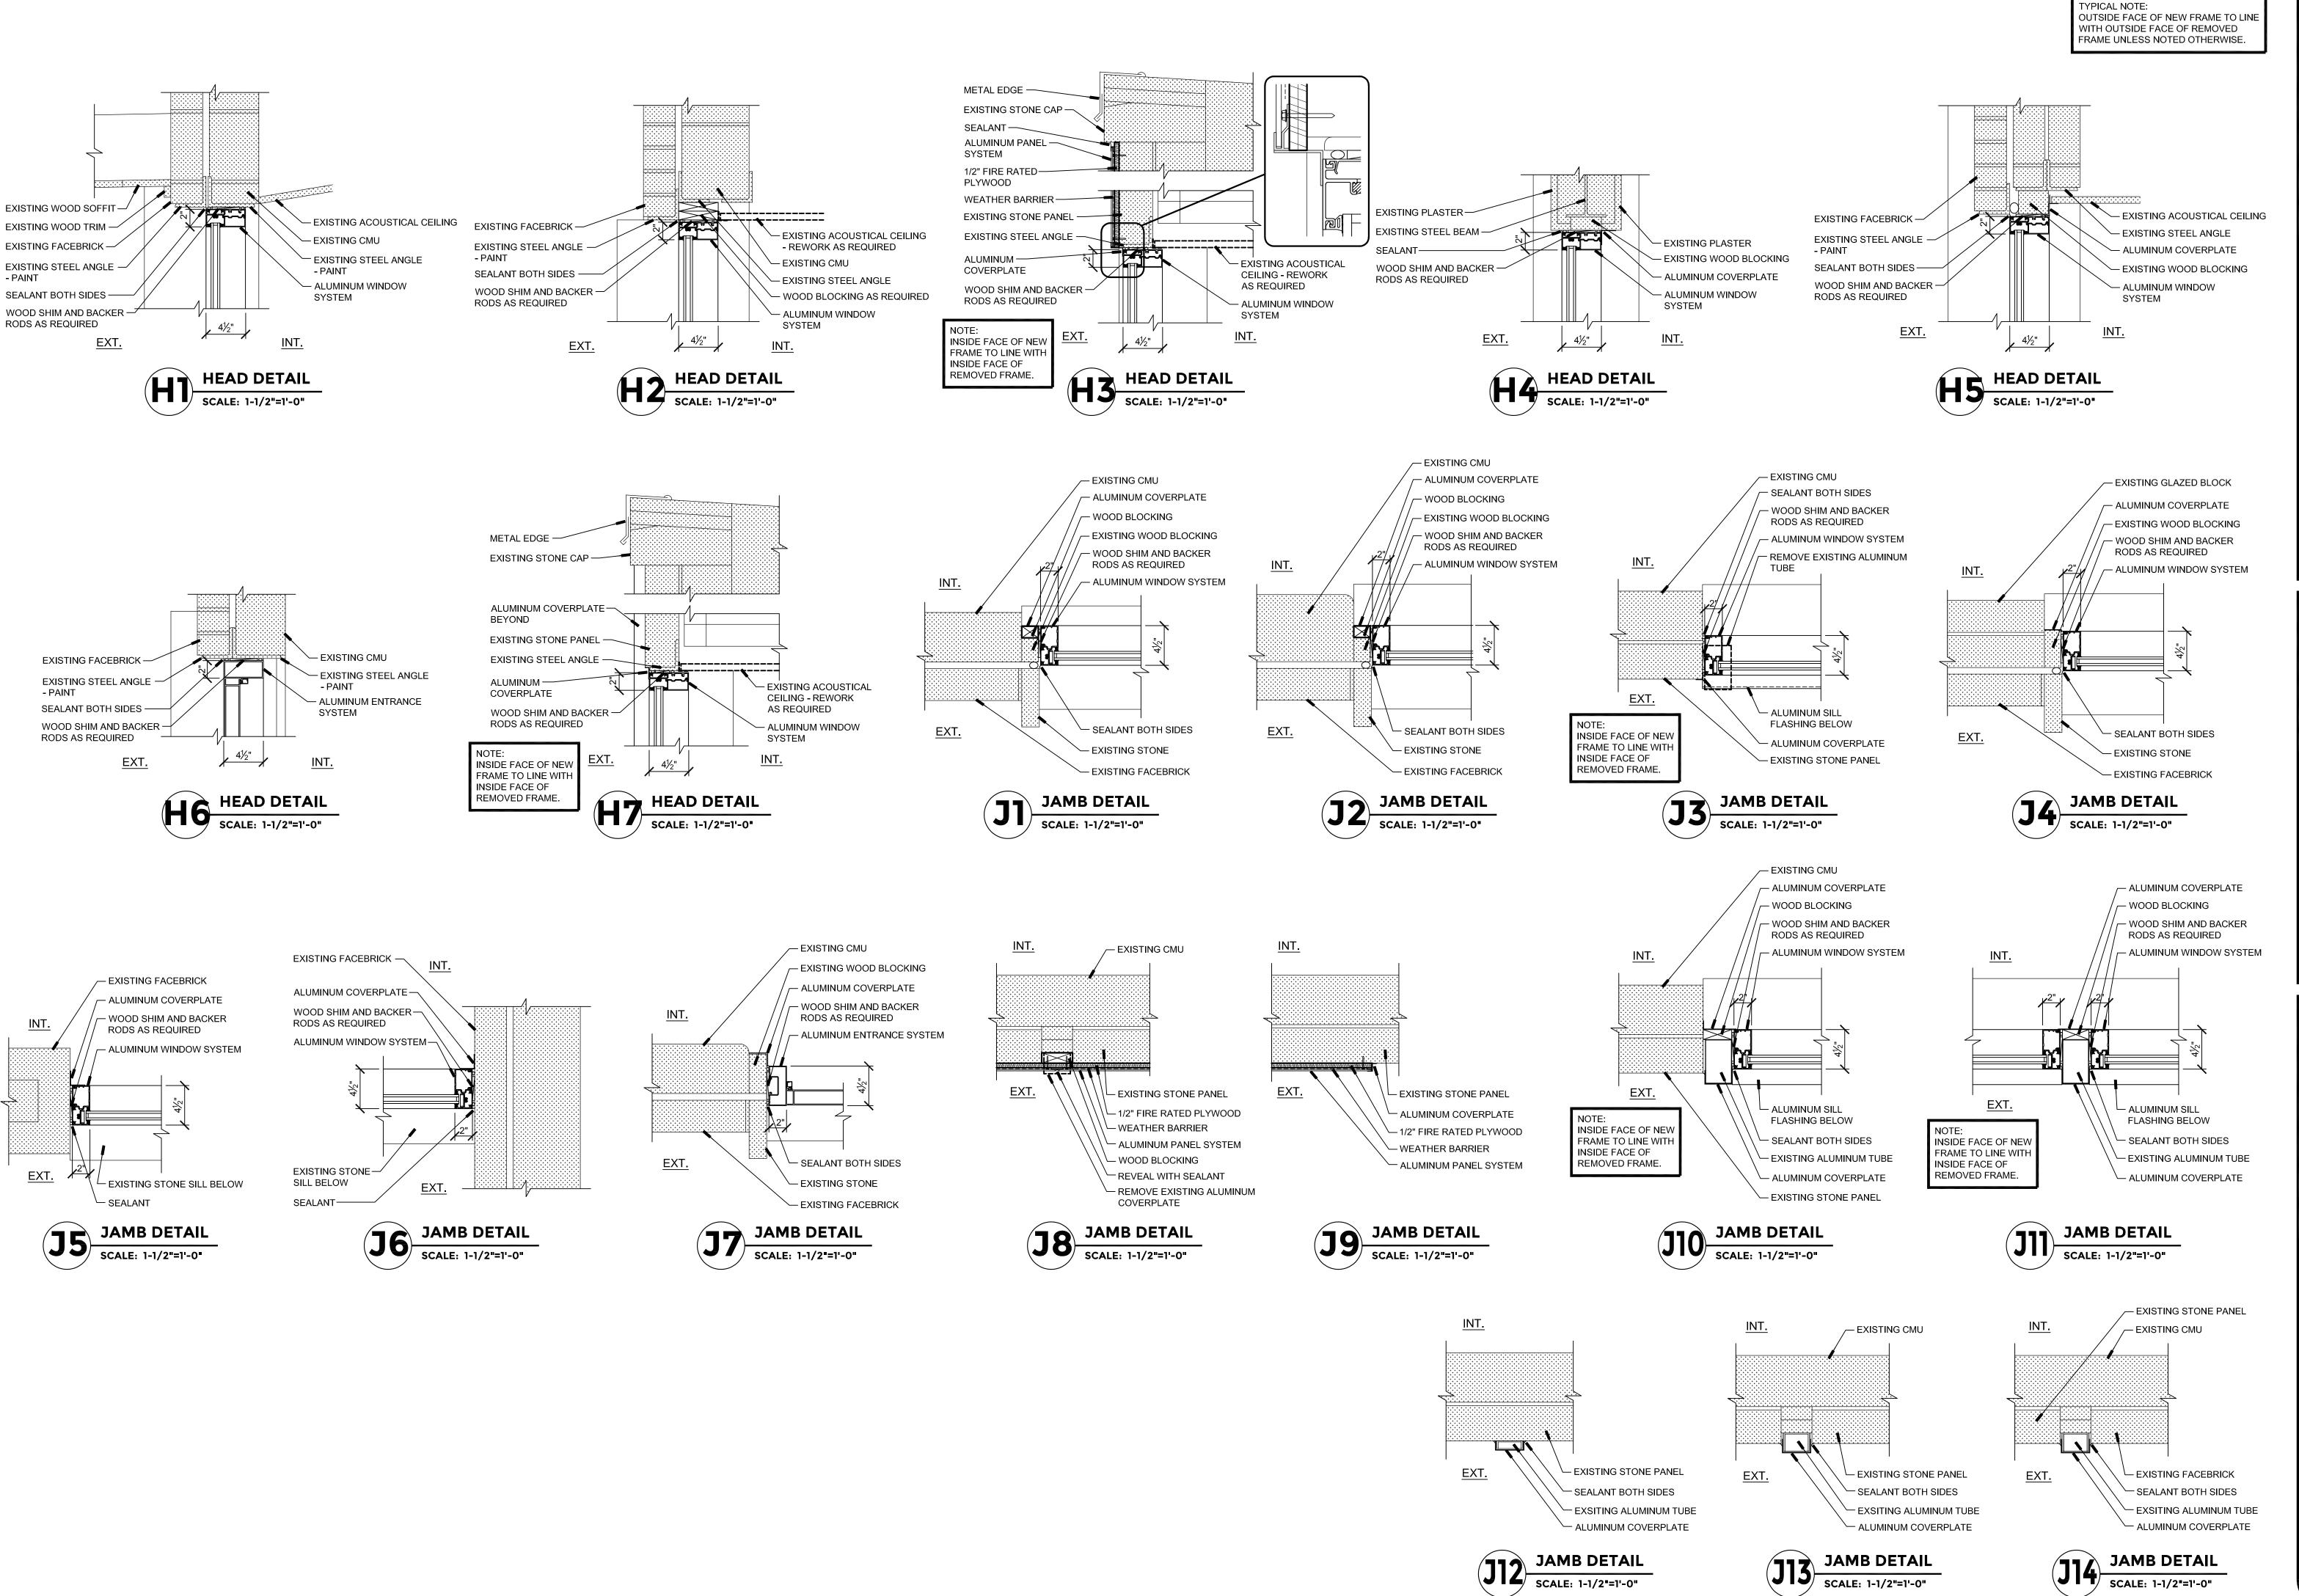FRAME UNLESS NOTED OTHERWISE.

- ALUMINUM WINDOW

SYSTEM W/ SUBSILL

— EXISTING TERRAZZO

- EXISTING CMU

INSIDE FACE OF NEW

FRAME TO LINE WITH

INSIDE FACE OF

REMOVED FRAME.

- ALUMINUM COVERPLATE

SET IN SEALANT

EXT.

ALUMINUM WINDOW — SYSTEM W/ SUBSILL SET IN SEALANT

ALUMINUM COVERPLATE —

EXISTING STONE PANEL -

EXISTING CONCRETE -FOUNDATION WALL


ALUMINUM SILL-FLASHING


BEYOND


SILL DETAIL


SCALE: 1-1/2"=1'-0"


SCALE: 1-1/2"=1'-0"

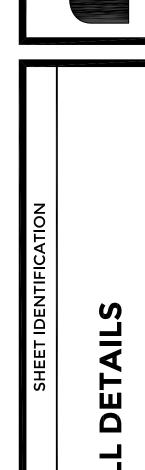

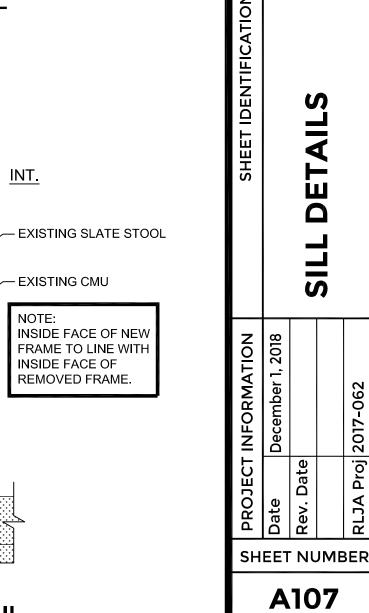


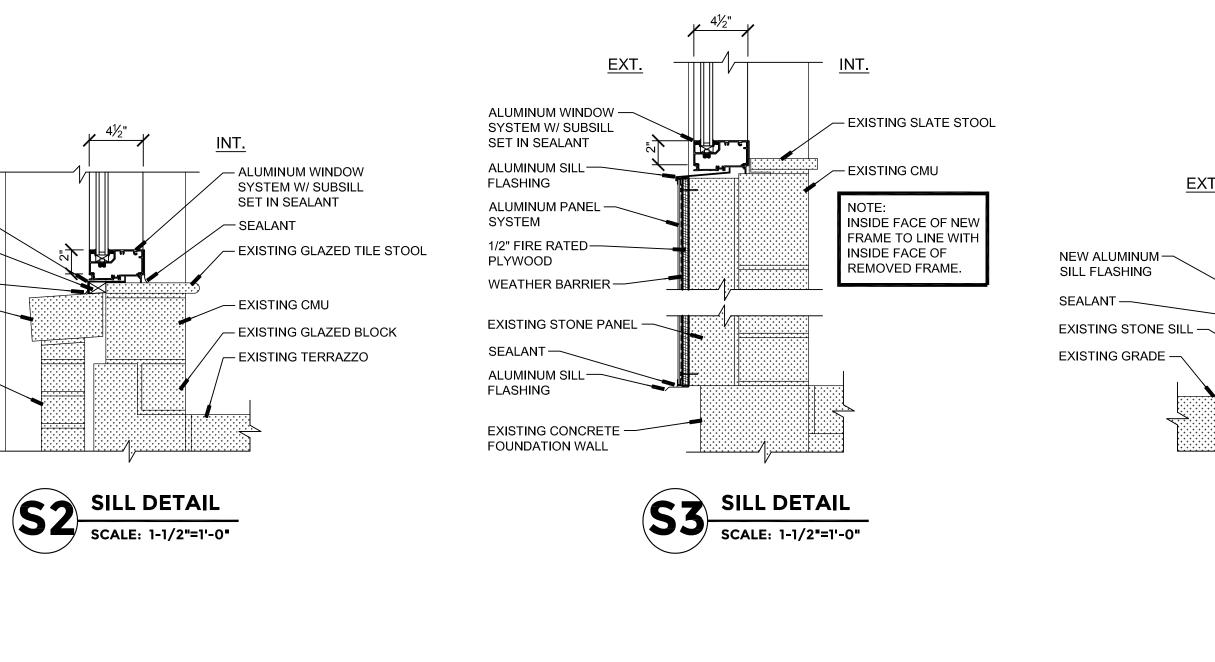


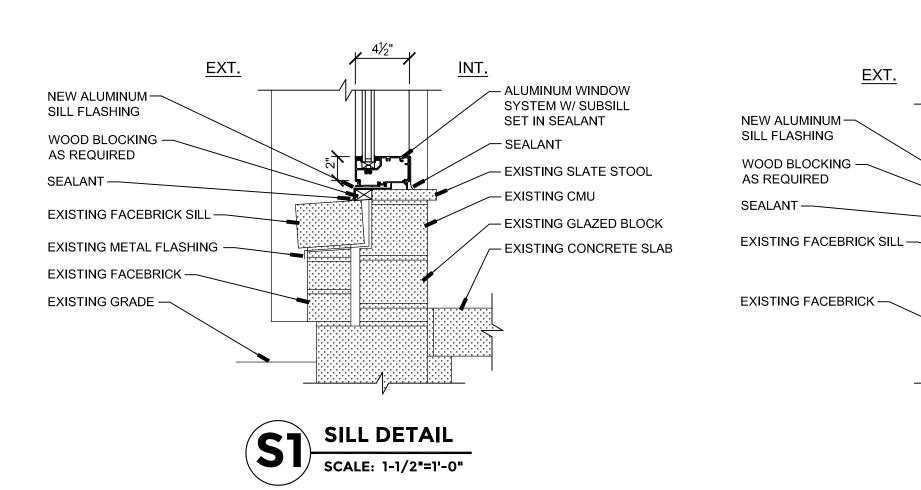

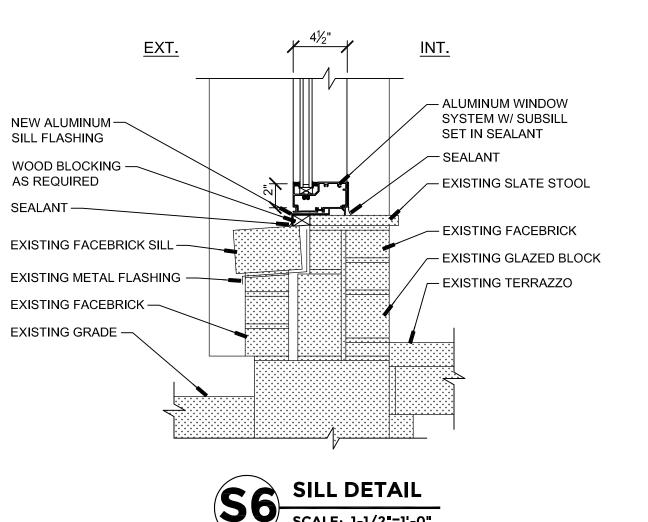

EXT.

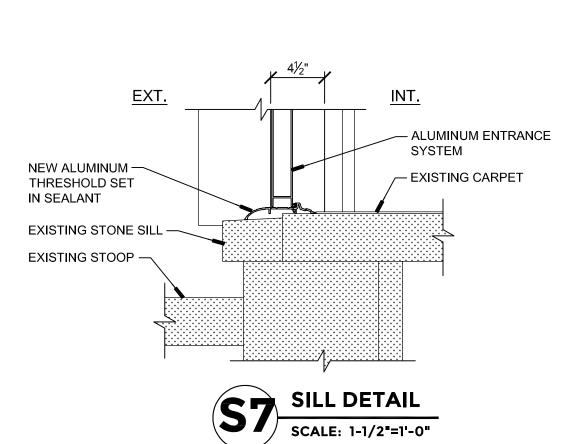

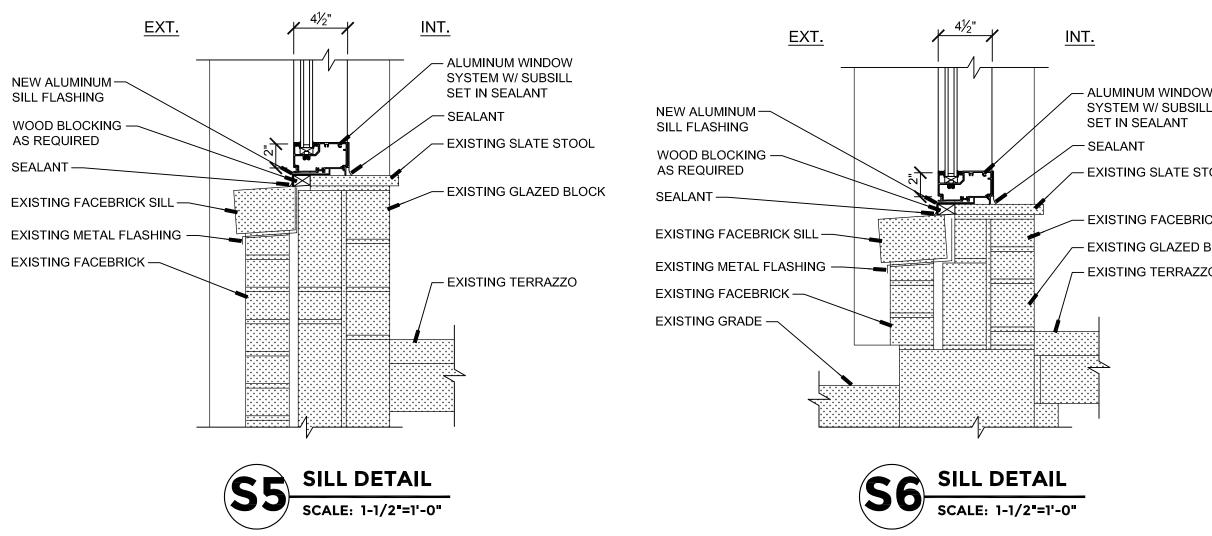

IFB 19-13 Asbestos Abatement Project at Froberg and Hillman Elementary Schools Pre-Bid Meeting Sign-In Sheet December 27, 2018 at 11:00 a.m.



# PRE-BID MEETING SIGN-IN SHEET

IFB 19-13 Asbestos Abatement Project at Froberg & Hillman Elementary Schools

-	PLEASE W	KII E EMAIL ADDRESS SO	PLEASE WRITE EMAIL ADDRESS SO THAT IT IS LEGIBLE IN ORDER TO RECEIVE ADDENDUM INFORMATION	EIVE ADDENDOM	INFORMALION	
	Printed Name	Company Name	Company Address	Telephone	E-mail	
	17			108 893	John, Cortis@	
<u>-</u>	1 John Curtis	Brock Industria	Brock Industrial 2010 OAK LEAF ST. JolieT	0139	Brockgroup, com	
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5	Montgomes	Keyn Martiames Valor Technologies	3 North point C+ Bolimbrain Il 288-724-2839	728-724-2839	Kenin Valoctechnologies Com	) may
	0	B	P		PP	
9	DANID CRABANA	HOJAR ABATEMENT	10CIF FRANKLIN AVE 14, 60131	708 933 4271	TOM ASE HO, ARIS GIRALLOW	
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ROCKFORD PUBLIC SCHOOLS
IFB 19-13 Aspestos Abatement Project at
Froberg and Hillman Elementary Schools
Pre-Bid Meeting Sign-In Sheet
December 27, 2018 at 11:00 a.m.



# PRE-BID MEETING SIGN-IN SHEET

IFB 19-13 Asbestos Abatement Project at Froberg & Hillman Elementary Schools

	Printed Name	Company Name	Company Address	Telephone	E-mail
			70/15/ FC	0139	brockgroup.com
_	1 John Curtis	Brock Industrial	2210 OALL LEAF ST, GOYSE	208822	John Cortis @
7	2 PAVID GRASSUNG	HUSAR ABATEMIENT	10215 FRANCION THE FRANKLIN MAKK (12,60131	728 ED3 4271	TOWAR. HUINE, OL WHE. OL
ო	Bill Rabellofer	HOlian	7504 Meyer Rd Spring Grave, It	815/215-6683	TIM P HOLIANING . COM
4		Buids Clornink Abel Plus Services	GY W END DY Gilberts, IL	8-17 3-46 5139	quide & abed plusserift &co
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