# MODULAR CLASSROOM BUILDING AT HILLMAN ELEMENTARY SCHOOL

ROCKFORD PUBLIC SCHOOLS 205
HILLMAN ELEMENTARY SCHOOL
3701 GREEN DALE DRIVE
ROCKFORD, ILLINOIS 61109

STATE MAP
SCALE: N.T.S.




#205

SCHOOLS

**OWNER** 

# ROCKFORD PUBLIC SCHOOL DISTRICT 205

501 SEVENTH STREET, ROCKFORD, ILLINOIS 61104

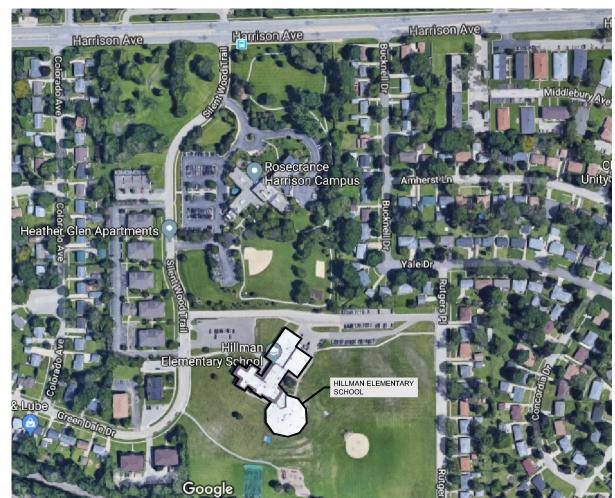


SITE LOCATION MAP SCALE: N.T.S.



### ARCHITECT OF RECORD

RICHARD L. JOHNSON ASSOCIATES
4703 Charles Street
Rockford IL. 61108
PHONE: 815/398-1231 FAX 815/398-1280
www.rljarch.com
IL. Design Firm No. 187-000524

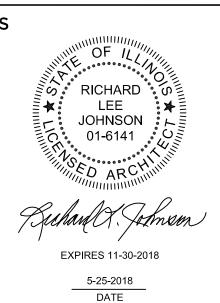

## SHEET INDEX

#### TITLE SHEET

T101 TITLE SHEET

#### ARCHITECTURAL

A101 PARTIAL SITE PLAN, FLOOR PLAN, ELEVATIONS, DETAILS AND NOTES

DETAILS AND NOTE:

A102 TYPICAL MODULAR FLOOR PLAN, FOUNDATION PLAN, DETAILS AND NOTES



SHEET IDENTIFICATION

ITLE SHEET

SHEET NUMBER

**T101** OF

MODULAR CLASSROOM E HILLMAN ELEMENTARY S ROCKFORD, ILLINOIS

OHNSON RICHARD

PARTIAL SITE PLAN, PLAN, ELEVATIONS, DETAILS AND NOTES

SHEET NUMBER

A101



- CONTRACTOR SHALL RESTORE ANY DAMAGED PAVED, PLANTED AND PLAY FIELDS TO IT'S PRECONSTRUCTION CONDITION.
- 2. VERIFY LOCATION OF ALL UTILITIES PRIOR TO CONSTRUCTION.
- B. ELECTRICAL FEED TO MODULAR CLASSROOMS BY OWNER. . CONTRACTOR SHALL MOVE THE MODULAR BUILDING FROM

# AUBURN TO HILLMAN.

#### KEY NOTES

- $\langle 1 \rangle$  (1) CLASSROOM MODULAR BUILDING PROVIDED BY OWNER.
- $\langle 2 \rangle$  TREATED WOOD RAMP.
- 5 FINISHED FLOOR HEIGHT OF NEW MODULAR SHALL BE (+2'-6" -VERIFY WITH MODULAR BUILDING SUPPLIER) ABOVE EXISTING GRADE WHERE NEW RAMP MEETS NEW CONCRETE SIDEWALK.
- > NEW 5" CONCRETE SIDEWALK OVER 4" CA-6 GRANULAR FILL -TOP OF CONCRETE TO MATCH TOP OF EXISTING SIDEWALK -
- ANCHOR DECK AREA TO MODULAR BUILDING AS REQUIRED.

- (3) TREATED WOOD DECK.
- TREATED WOOD STAIR SYSTEM WITH 11" TREADS AND MAX 7" RISER CLOSED - VERIFY EXACT QUANTITY REQUIRED IN FIELD.

- DOWEL INTO EXISTING CONCRETE SIDEWALK 6" AND EPOXY #4 DOWEL 1'-0" LONG @ 18" O.C.
- 7> PROVIDE METAL ADA THRESHOLD AT BOTTOM OF RAMP.

ELEVATION NOTES

PLAN NOTES

OF RAMP(S).

- . SEE SPECIFICATIONS FOR MATERIALS/FINISHES.
- 2. STAIRS AND RAMPS NOT SHOWN FOR CLARITY.
- PROVIDE SKIRT FROM BOTTOM OF BUILDING TO TOP OF GRADE BELOW. PROVIDE VENTILATION LOUVERS AS CALLED FOR IN SPECIFICATIONS.

HANDRAILS AT STAIR TO EXTEND 1'-11" PAST THE BOTTOM RISER. HANDRAILS AT TOP OF STAIR TO EXTEND 12" PAST TOP RISER.

. HANDRAILS AT RAMP TO EXTEND 12" PAST THE BOTTOM AND TOP

3. NO RAMP SECTION TO BE LONGER THAN 30' WITHOUT A LANDING.


MANUFACTURER TO ADJUST RAMP LENGTH DEPENDING ON

. PROVIDE NON-SKID COATING ON STAIR TREADS AND NOSINGS.

4. HANDRAILS AND GUARDRAILS NOT SHOWN FOR CLARITY.

HEIGHT OF THE FINISHED FLOOR TO THE GRADE.

PROVIDE GUTTERS, DOWNSPOUTS AND SPLASH BLOCKS AS CALLED FOR IN SPECIFICATIONS.

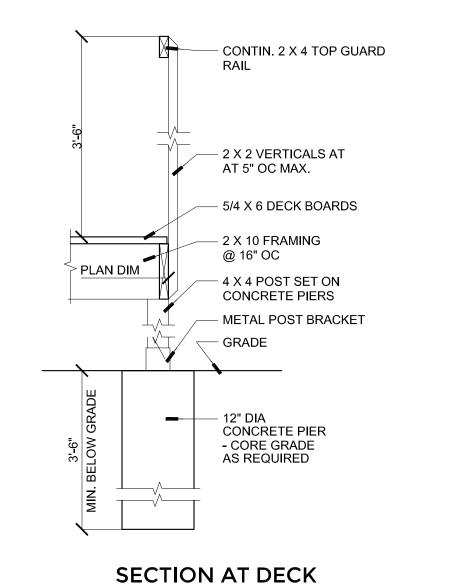

SCALE: N.T.S.

CONTIN. 2 X 4 TOP GUARD

— 5/4 X 6 @ RAMP AND STAIR

— 2 X 10 STRINGERS @ 16" OC RAMP AND STAIR

— 1 1/2" DIA HANDRAIL

2 X 2 VERTICALS AT

4 X 4 POST SET ON CONCRETE PIERS

CONCRETE PIER

- CORE GRADE AS REQUIRED

- GRADE


**SECTION AT RAMP AND STAIR** 


METAL POST BRACKET


AT 5" OC MAX.

PLAN DIM

SCALE: N.T.S.

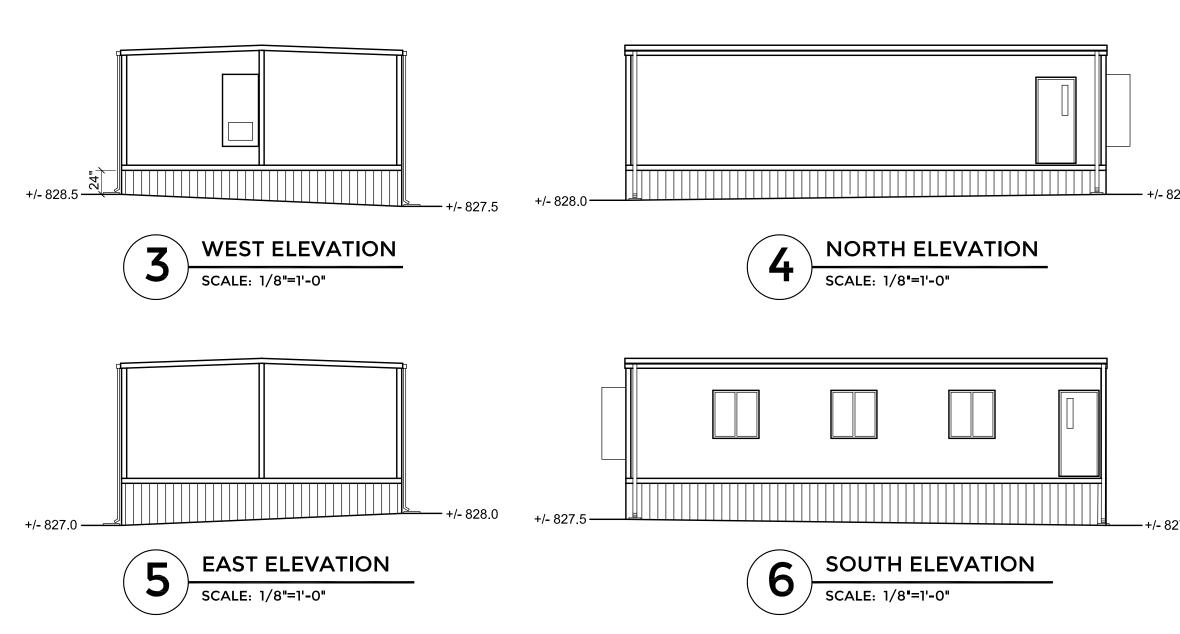

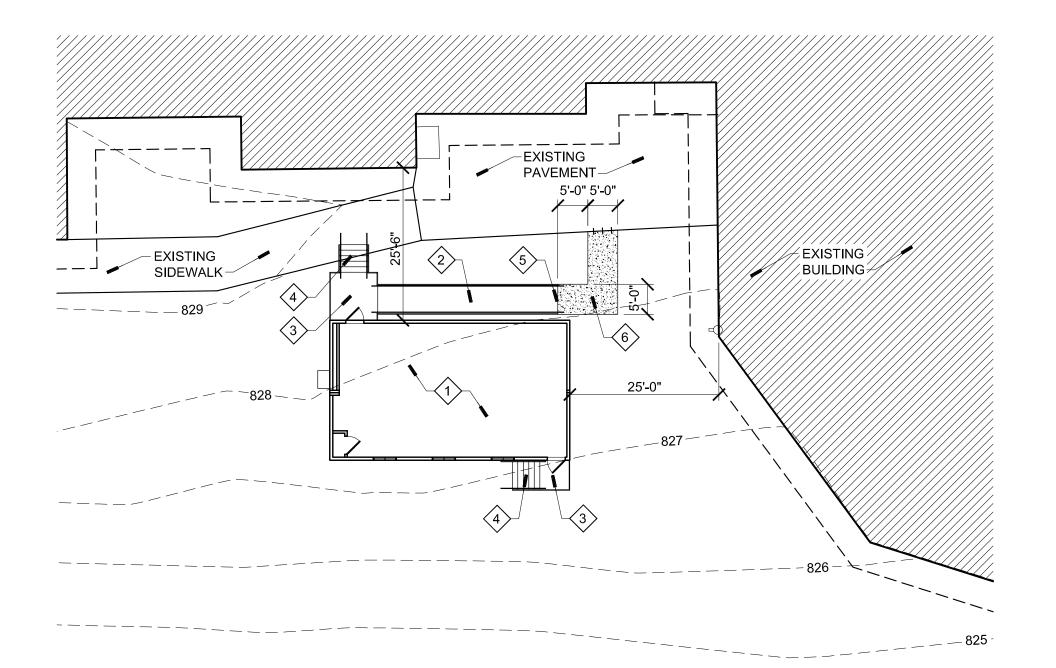

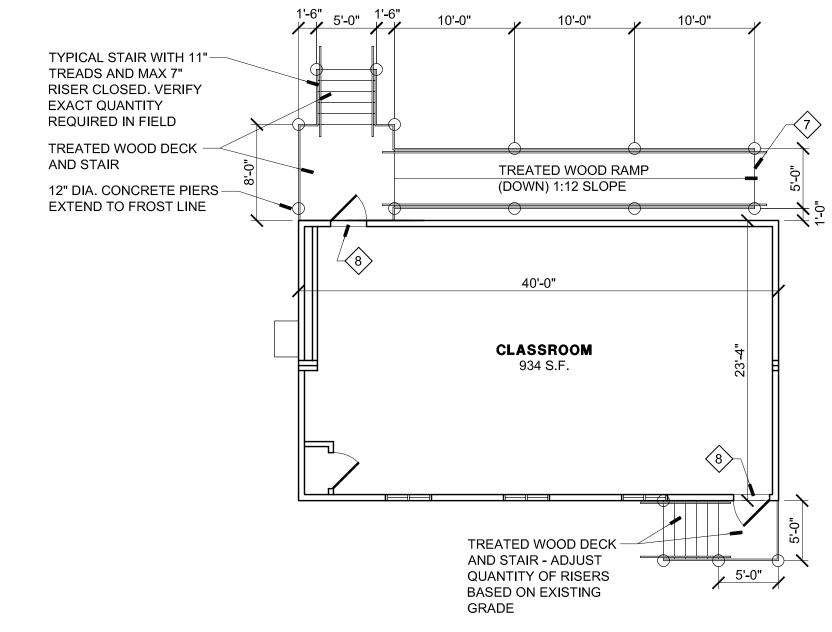



ISSUED FOR:
PROGRESS PERMIT
BIDDING CONSTRUCTION
SHEET DESCRIPTION:
FOUNDATION
PLAN

S1


SHEET NUMBER A102

MODULAR FOUNDATION PLAN SCALE: N.T.S. FOR REFERENCE ONLY

4. ELEVATIONS SHOWN ON FOOTINGS INDICATE TOP OF FOOTING.


6. SEE SHEET SO FOR GENERAL STRUCTURAL NOTES.

5. THE GENERAL CONTRACTOR IS TO FIELD VERIFY ALL EXISTING CONDITIONS AND DIMENSIONS PRIOR TO SUBMITTING SHOP DRAWINGS. IF CONDITIONS OR DIMENSIONS VARY FROM THOSE SHOWN ON THE CONSTRUCTION DRAWINGS, CONTACT THE ARCHITECT PRIOR TO COMMENCING WITH CONSTRUCTION.

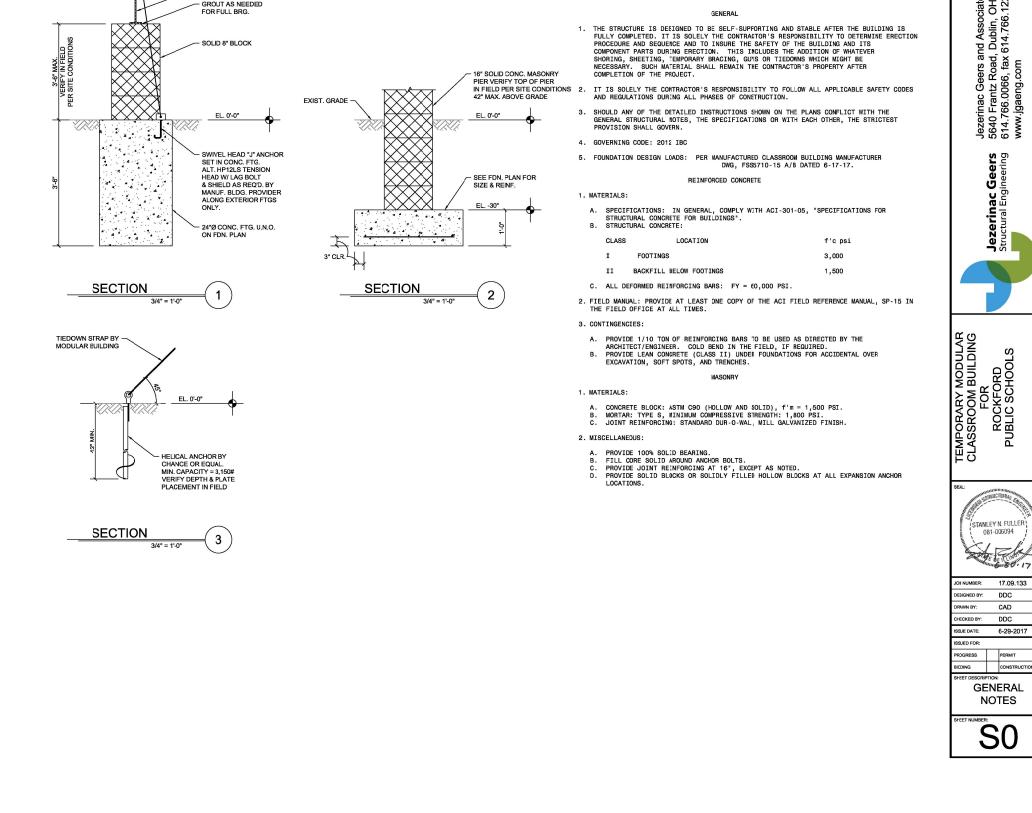

GENERAL STRUCTURAL NOTES

#### MODULAR FOUNDATION GENERAL NOTES SCALE: N.T.S. FOR REFERENCE ONLY

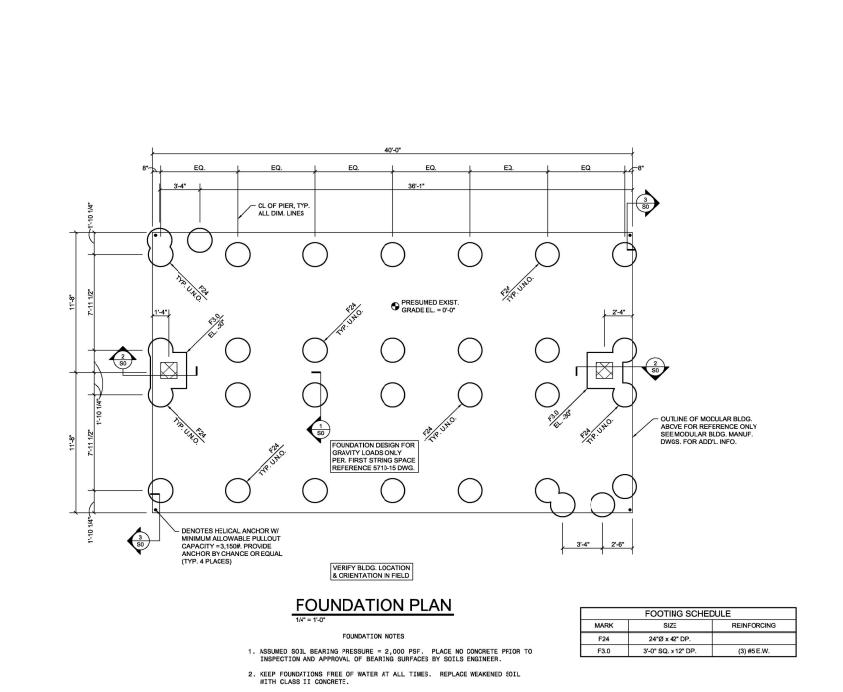

#### MODULAR CLASSROOM FLOOR PLAN SCALE: N.T.S. FOR REFERENCE ONLY

FOR CUSTOMER APPROVAL DATE: 6-21-2017

ALL MAKER AND TACK BOARDS TO BE AT 24" TO THE BOTTOM.

NEED MIN 6' 9" B/W MARKER AND TACK FOR SMART BOARD AND NEED BACKER BOARD FOR SMART BORAD