C

WINDOW REPLACEMENT AT KENNEDY MIDDLE SCHOOL


520 PIERPONT AVENUE ROCKFORD, ILLINOIS 61101

ROCKFORD PUBLIC SCHOOL DISTRICT 205


501 SEVENTH STREET ROCKFORD, ILLINOIS 61104






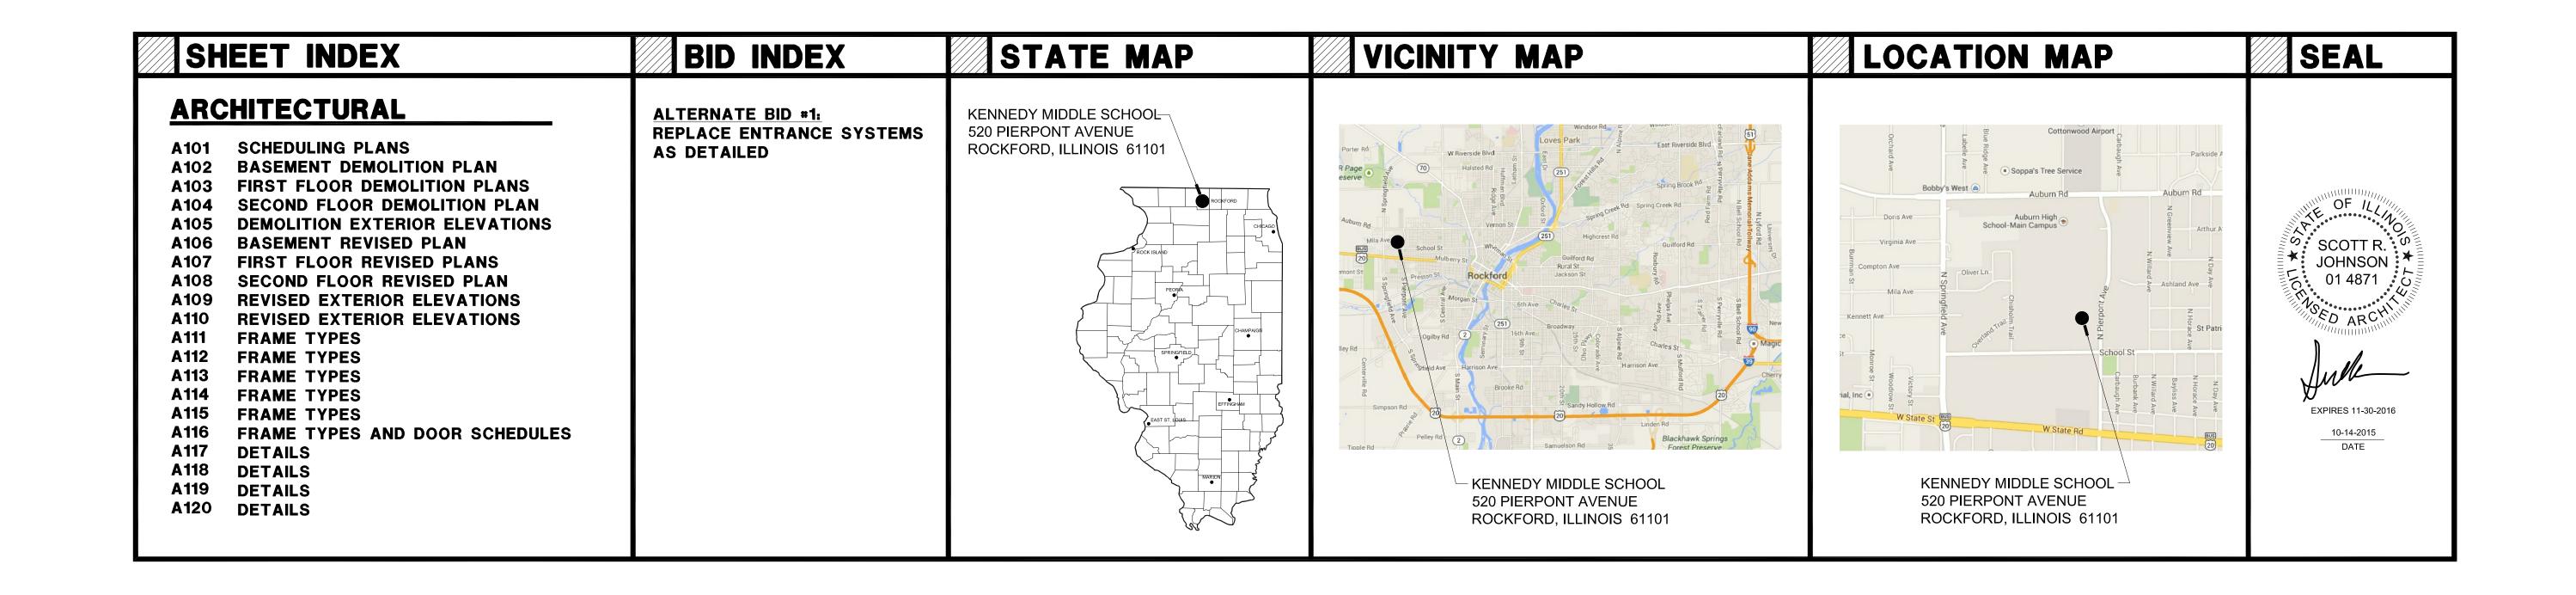


SHEET NUMBER A101 OF 20

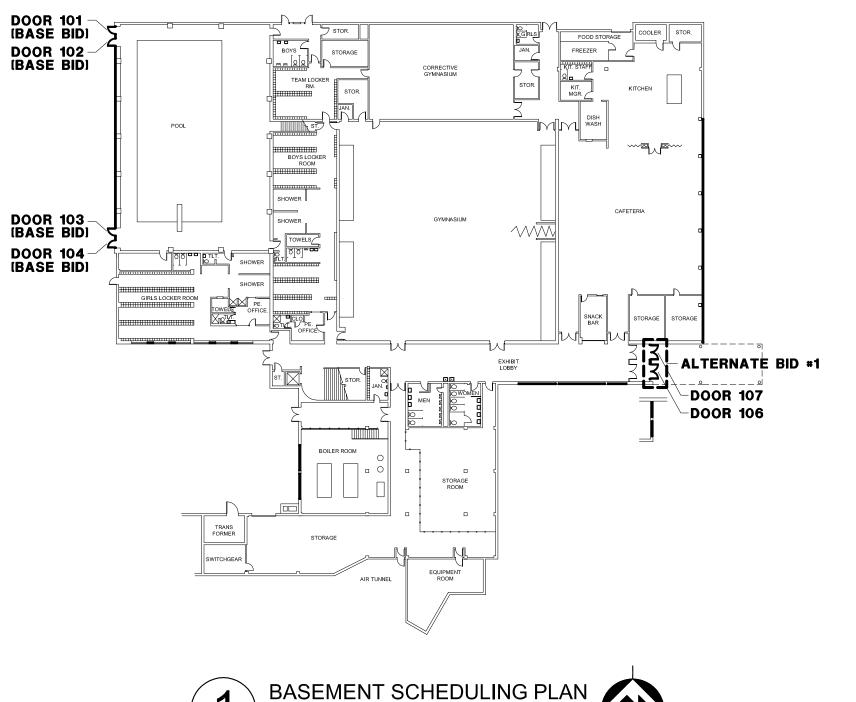

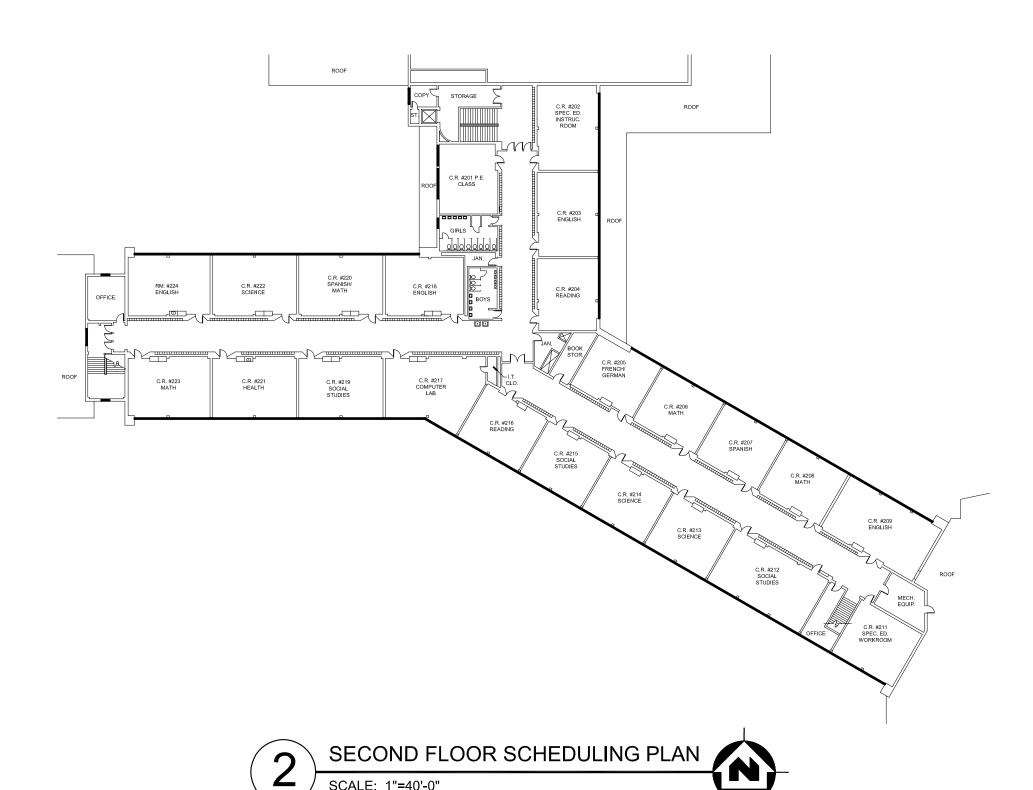

SCALE: 1"=40'-0"



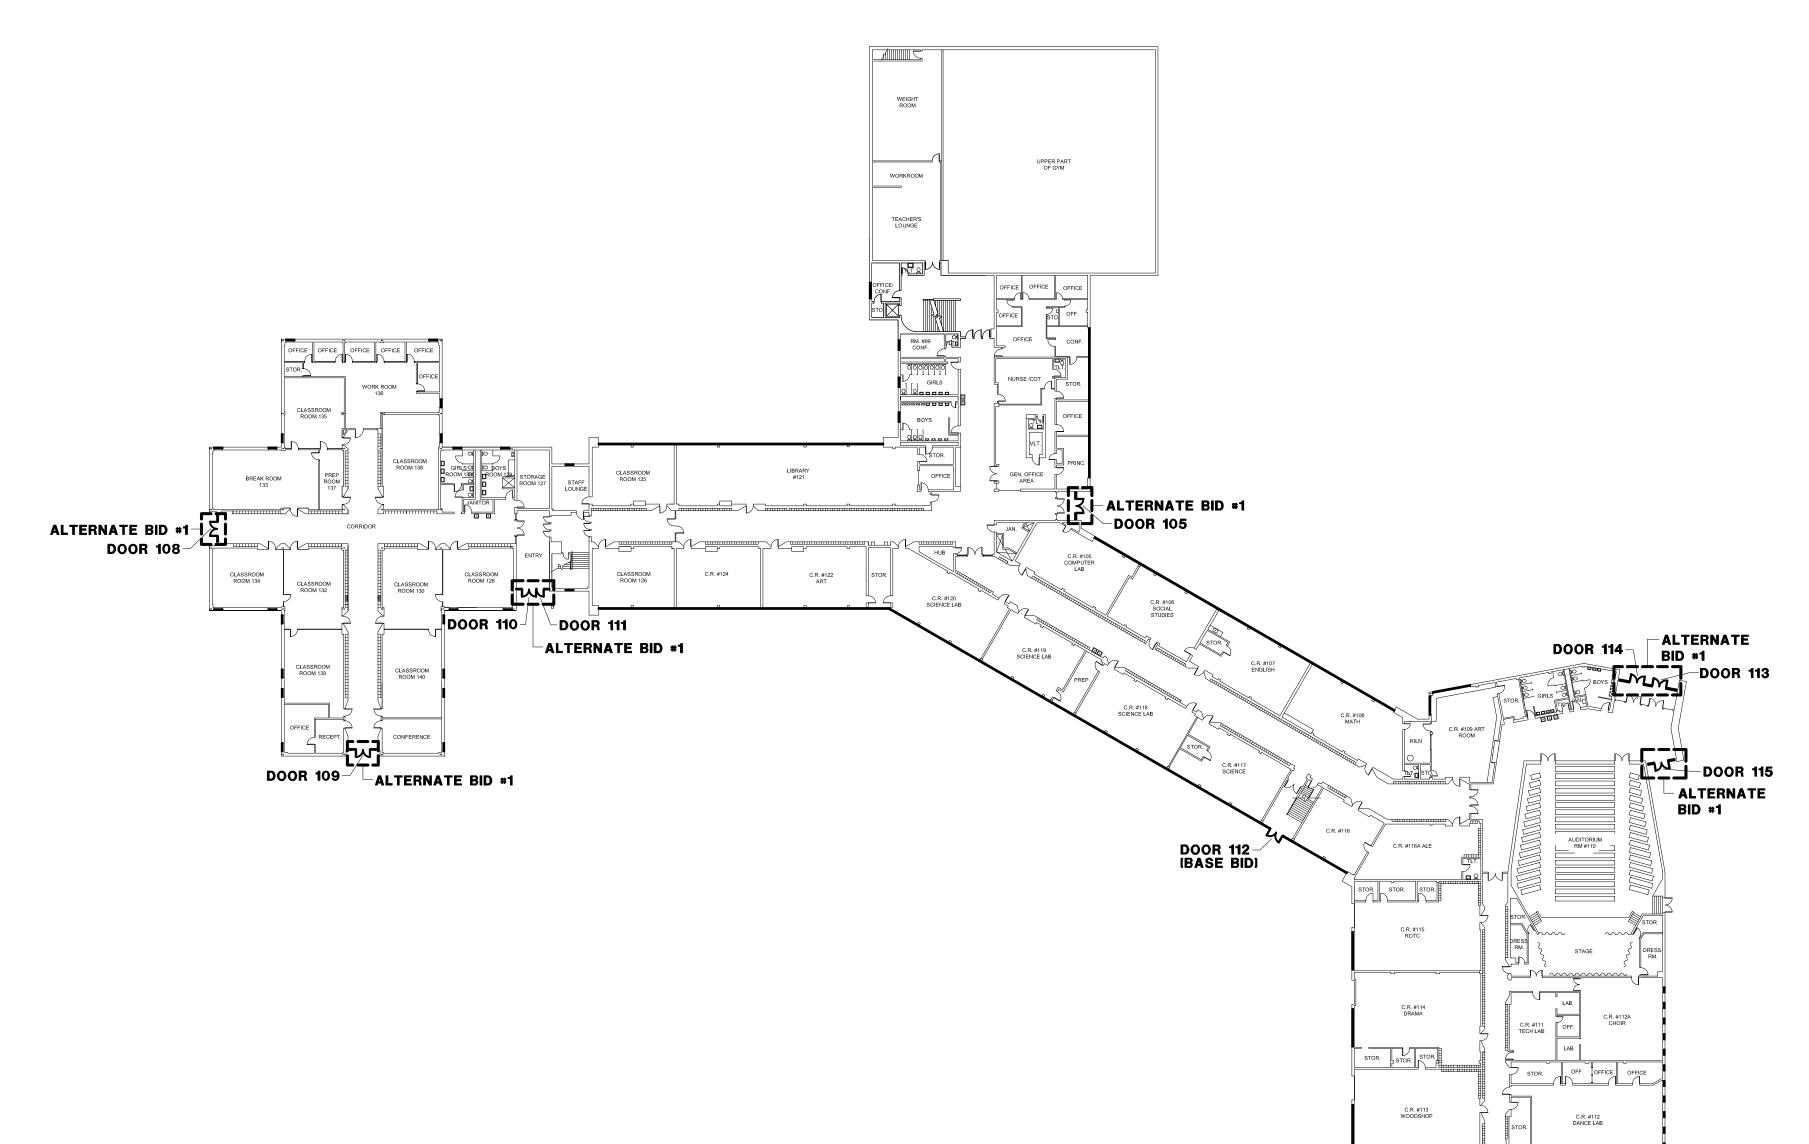

FIRST FLOOR SCHEDULING PLAN


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PROJECT SHALL BE CONSTRUCTED FOLLOWING THE 2009 INTERNATIONAL BUILDING CODE.

MOCK-UP DATES	
MOCK-UP SHOP DRAWINGS COMPLETE:	DECEMBER 4, 2015
REVIEW OF MOCK-UP SHOP DRAWINGS COMPLETE BY ARCHITECT:	DECEMBER 11, 2015
REMOVAL OF 1 WINDOW AND INSTALLATION OF TEMPORARY ENCLOSURE BY SEPARATE CONTRACTOR:	FEBRUARY 1, 2016
WINDOW CONTRACTOR TO REMOVE TEMPORARY ENCLOSURE AND INSTALL WINDOW.	FEBRUARY 8, 2016
MOCK-UP TESTING:	FEBRUARY 15, 2016

PROJECT START / COMPLETION DATES	
PROJECT START:	JUNE 7, 2016
PROJECT SUBSTANTIALLY COMPLETE:	AUGUST 5, 2016
FINAL COMPLETION - ALL PUNCH LIST ITEMS:	AUGUST 12, 2016




GENERAL DEMOLITION NOTES

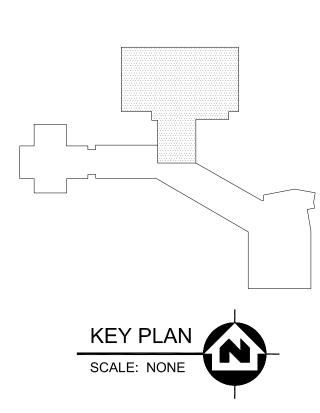
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- PROVIDE ALL TEMPORARY SHORING AS REQUIRED TO SUPPORT STRUCTURES AND FINISHES TO REMAIN.
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DEMOLITION BOX NOTES

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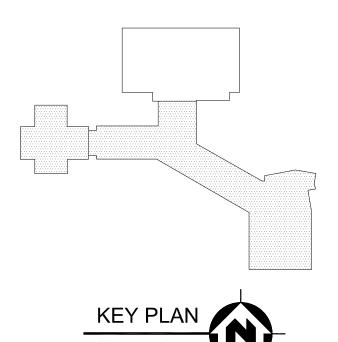




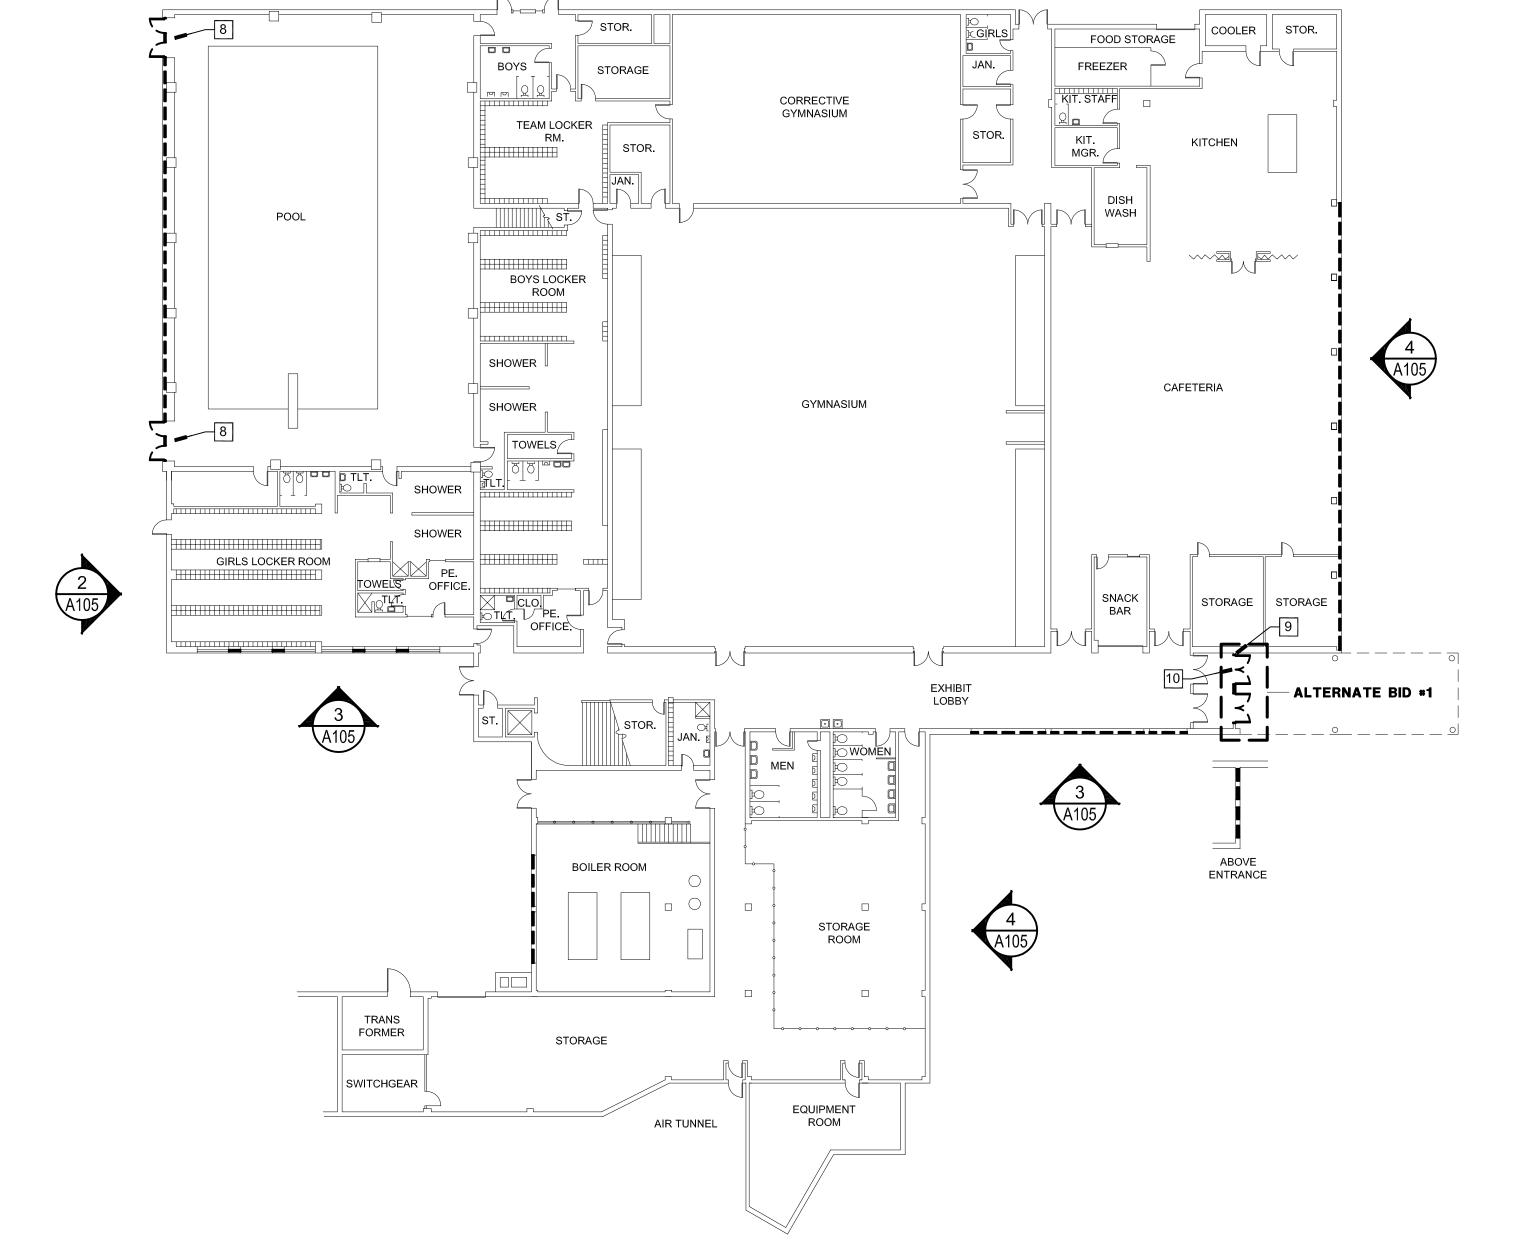

FIRST FLOOR DEMOLITION PLAN

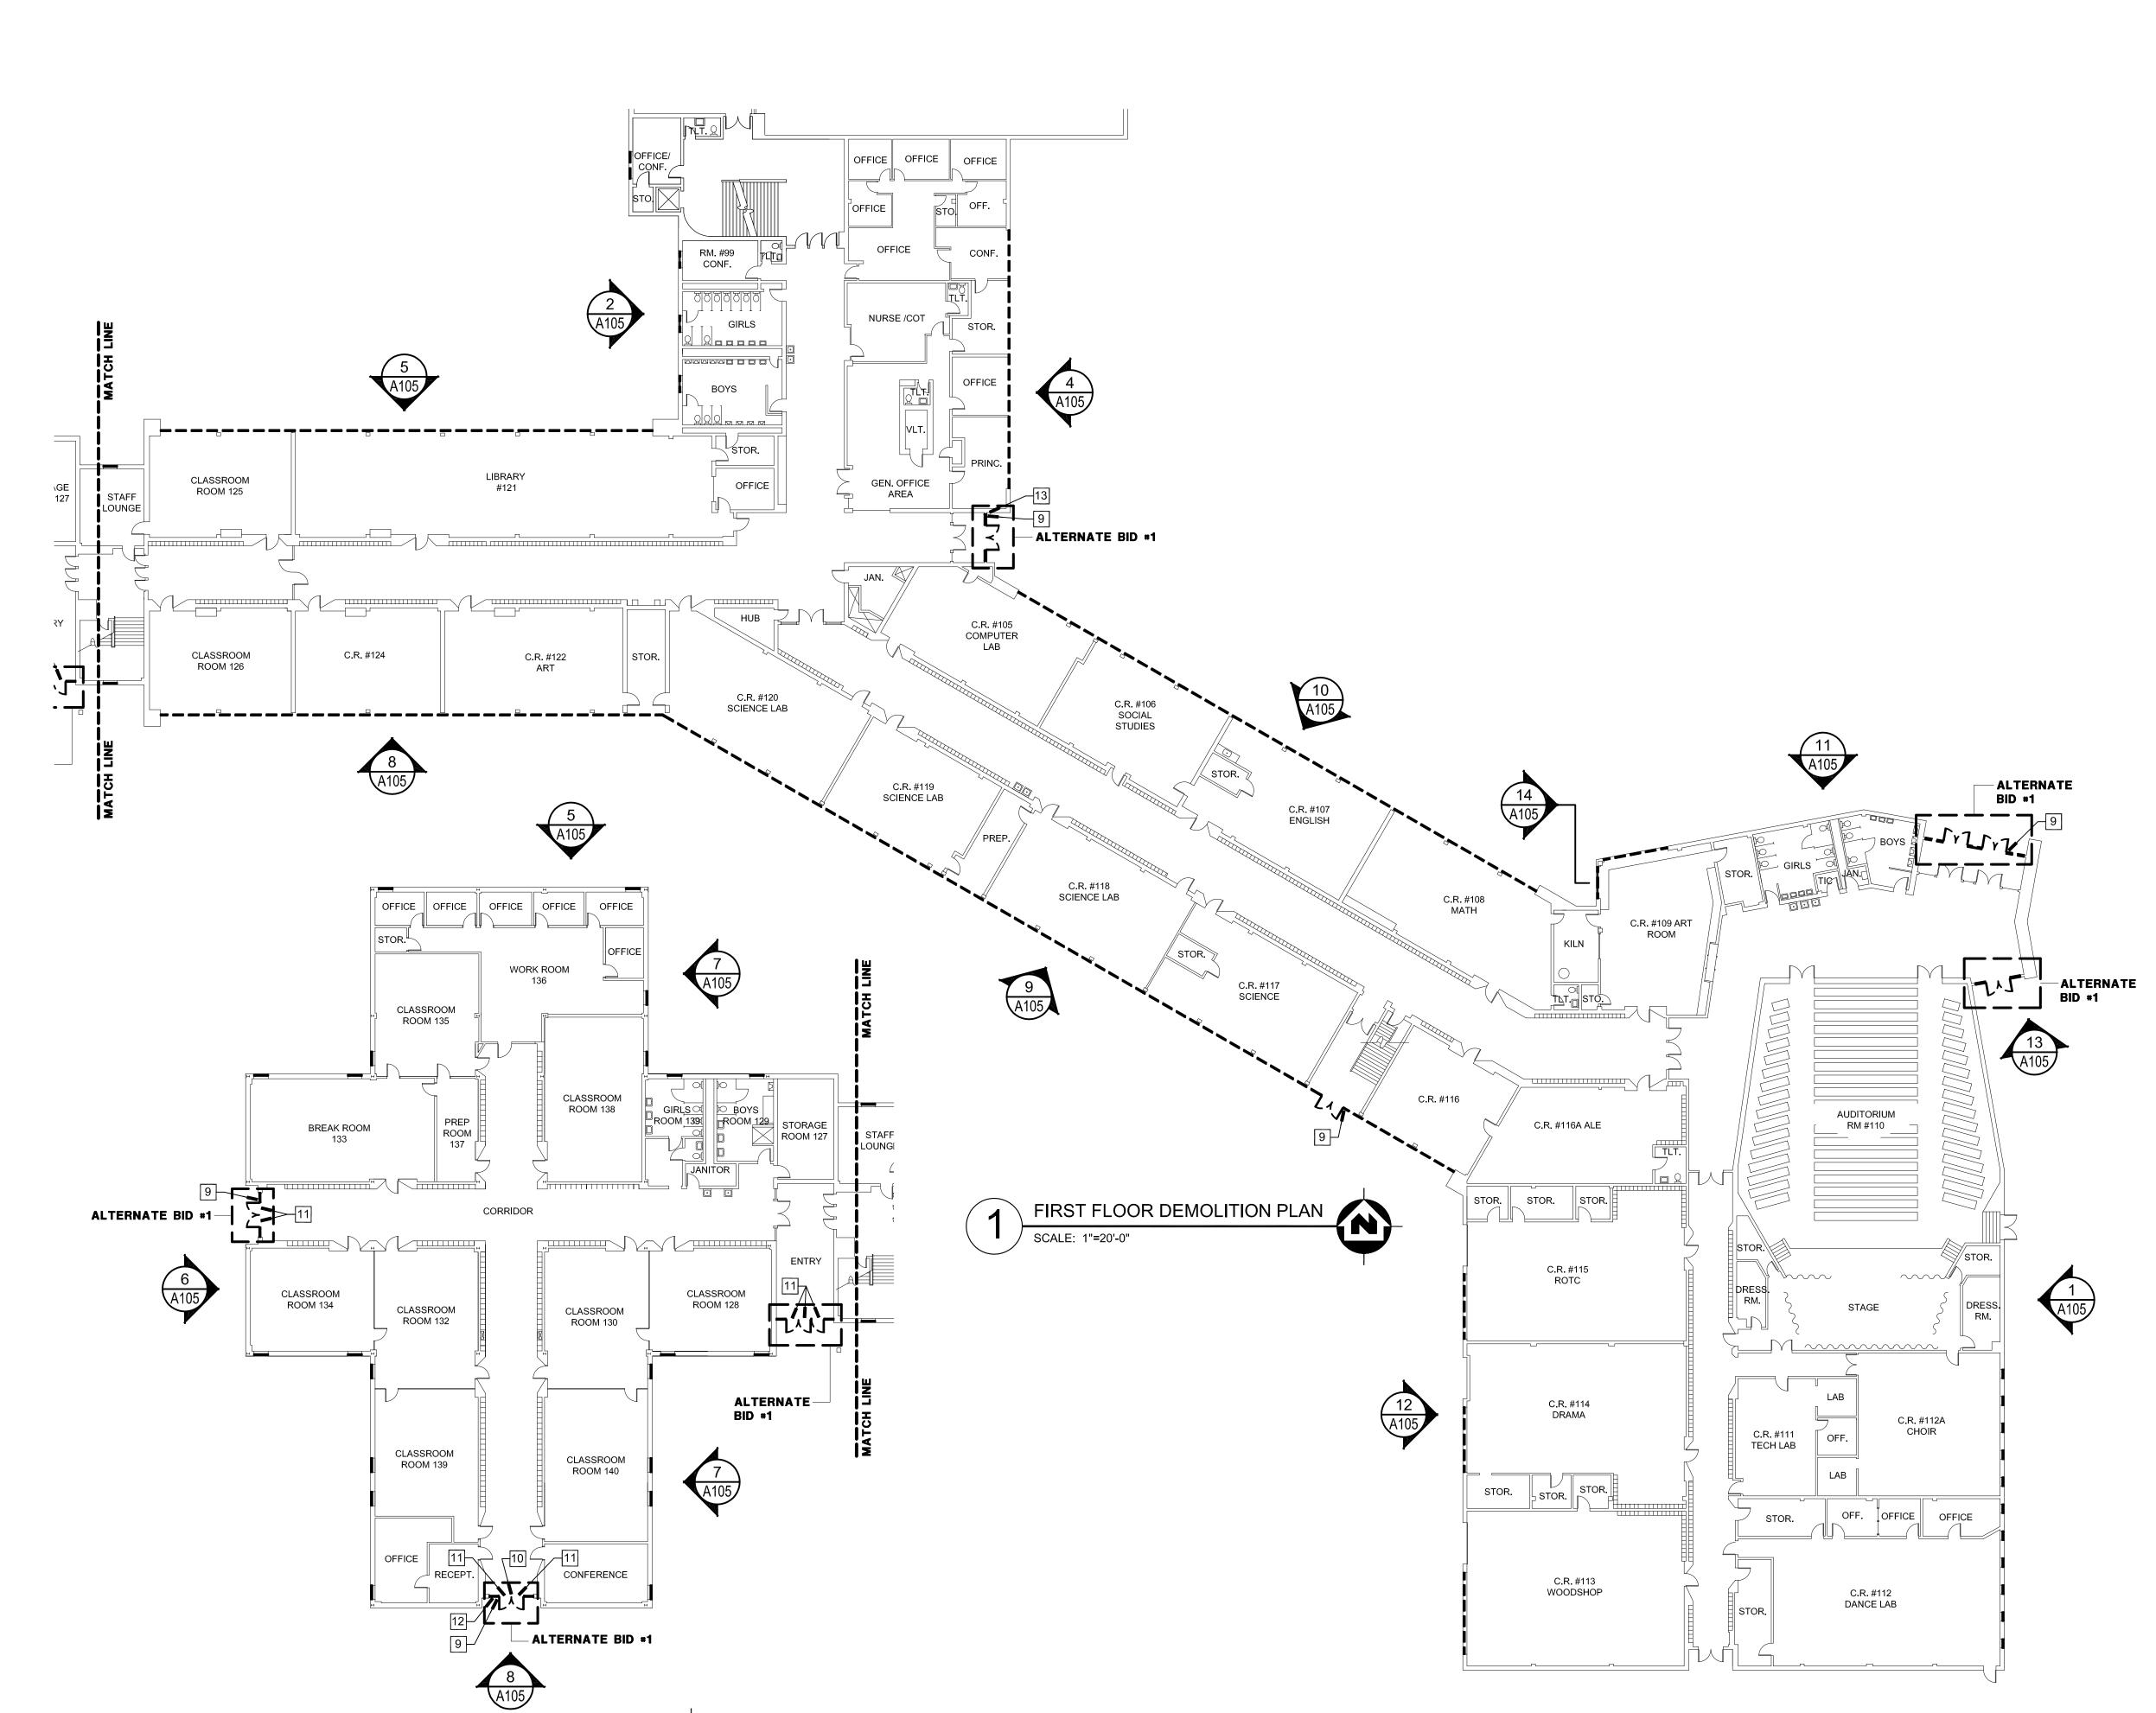
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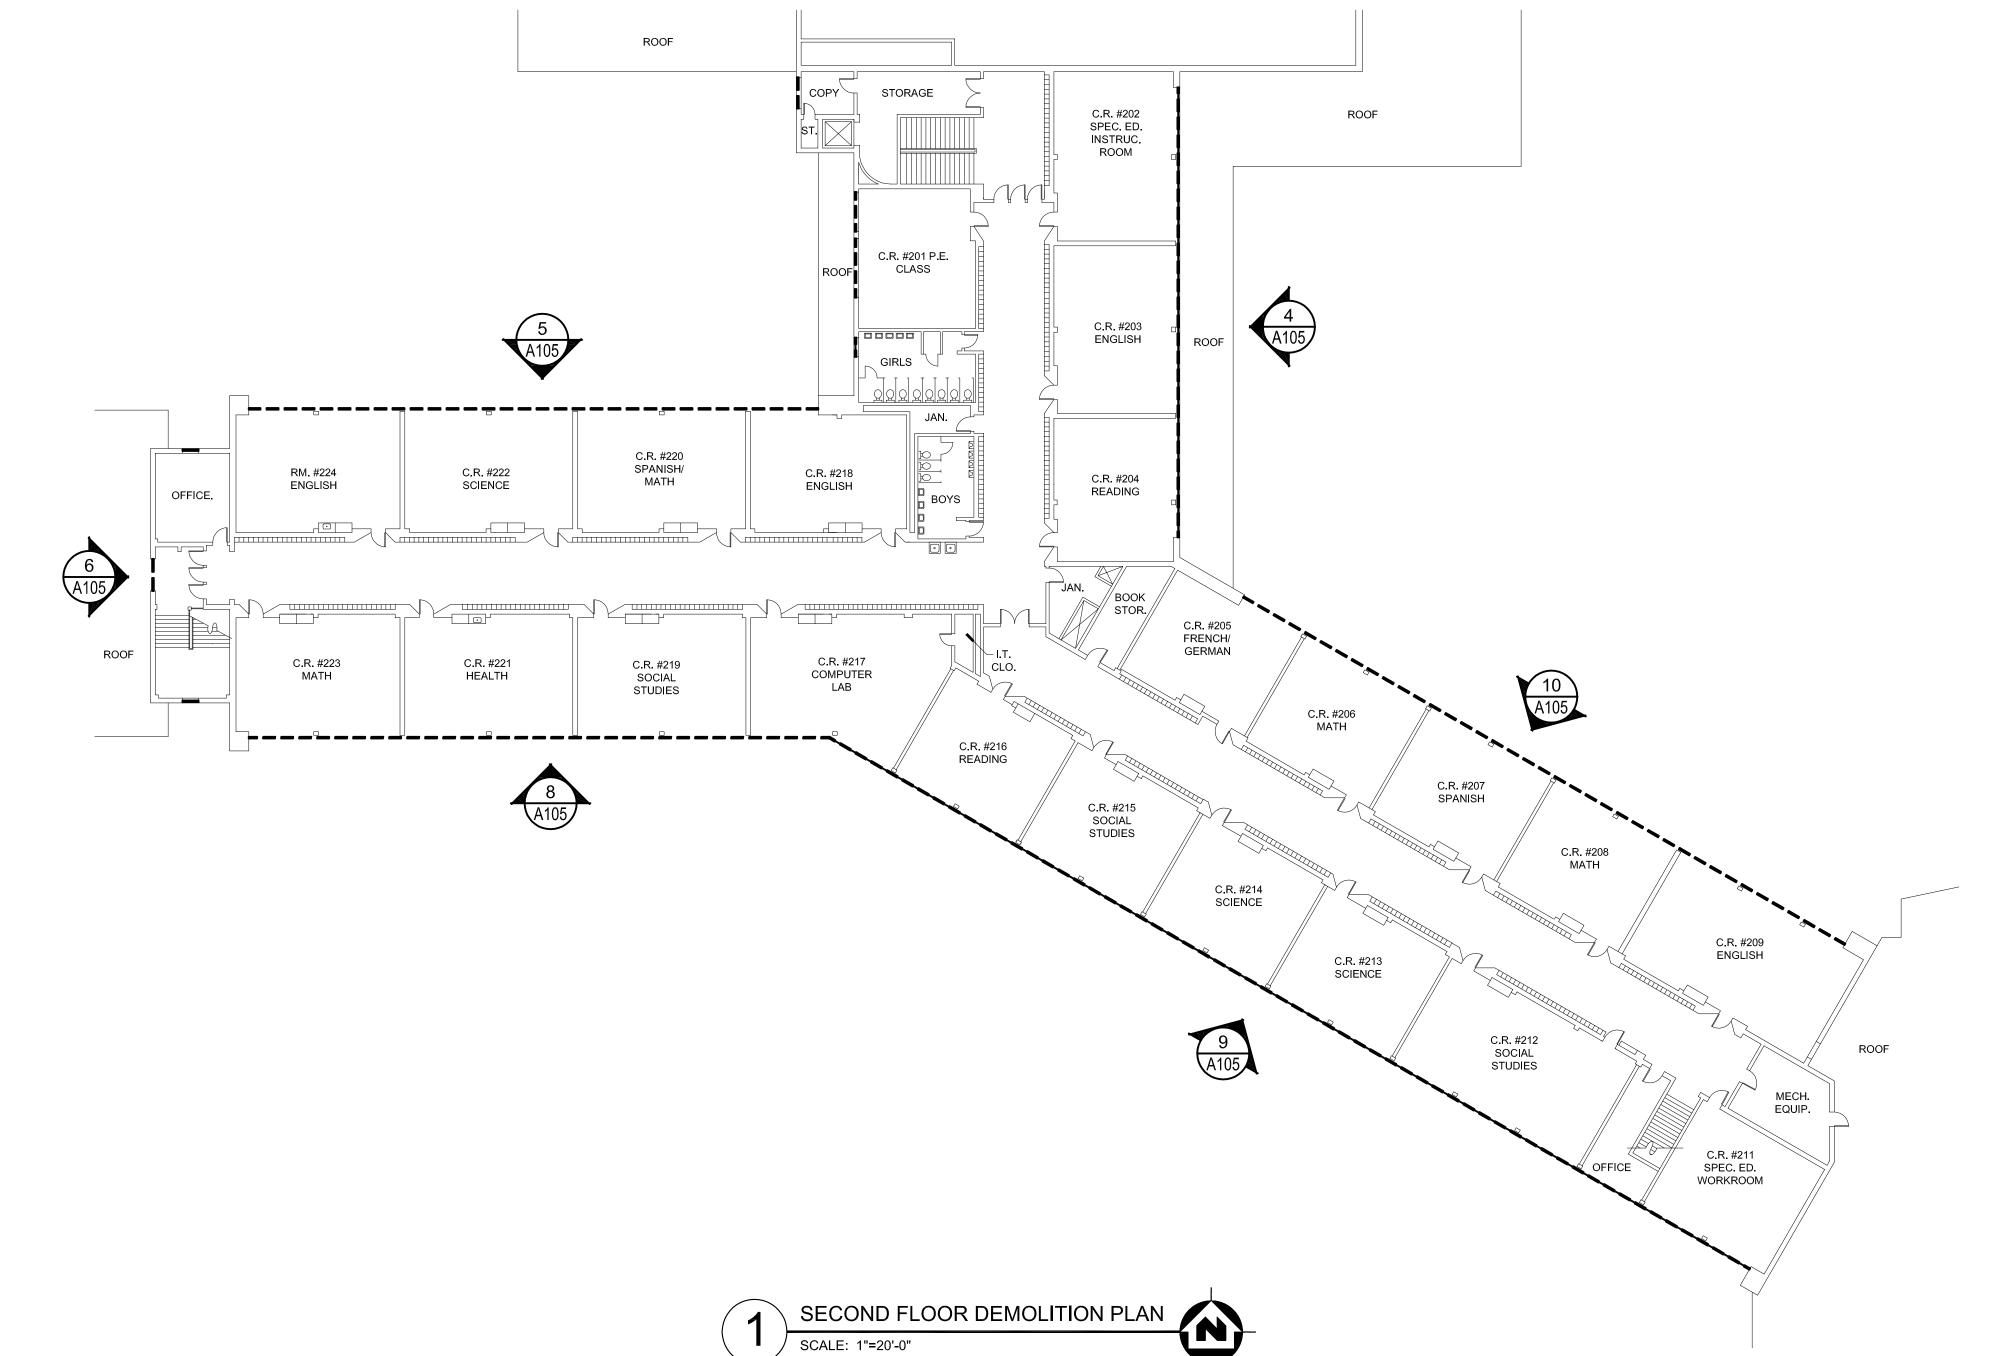



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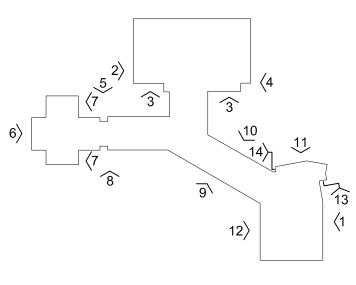
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KEY PLAN SCALE: NONE


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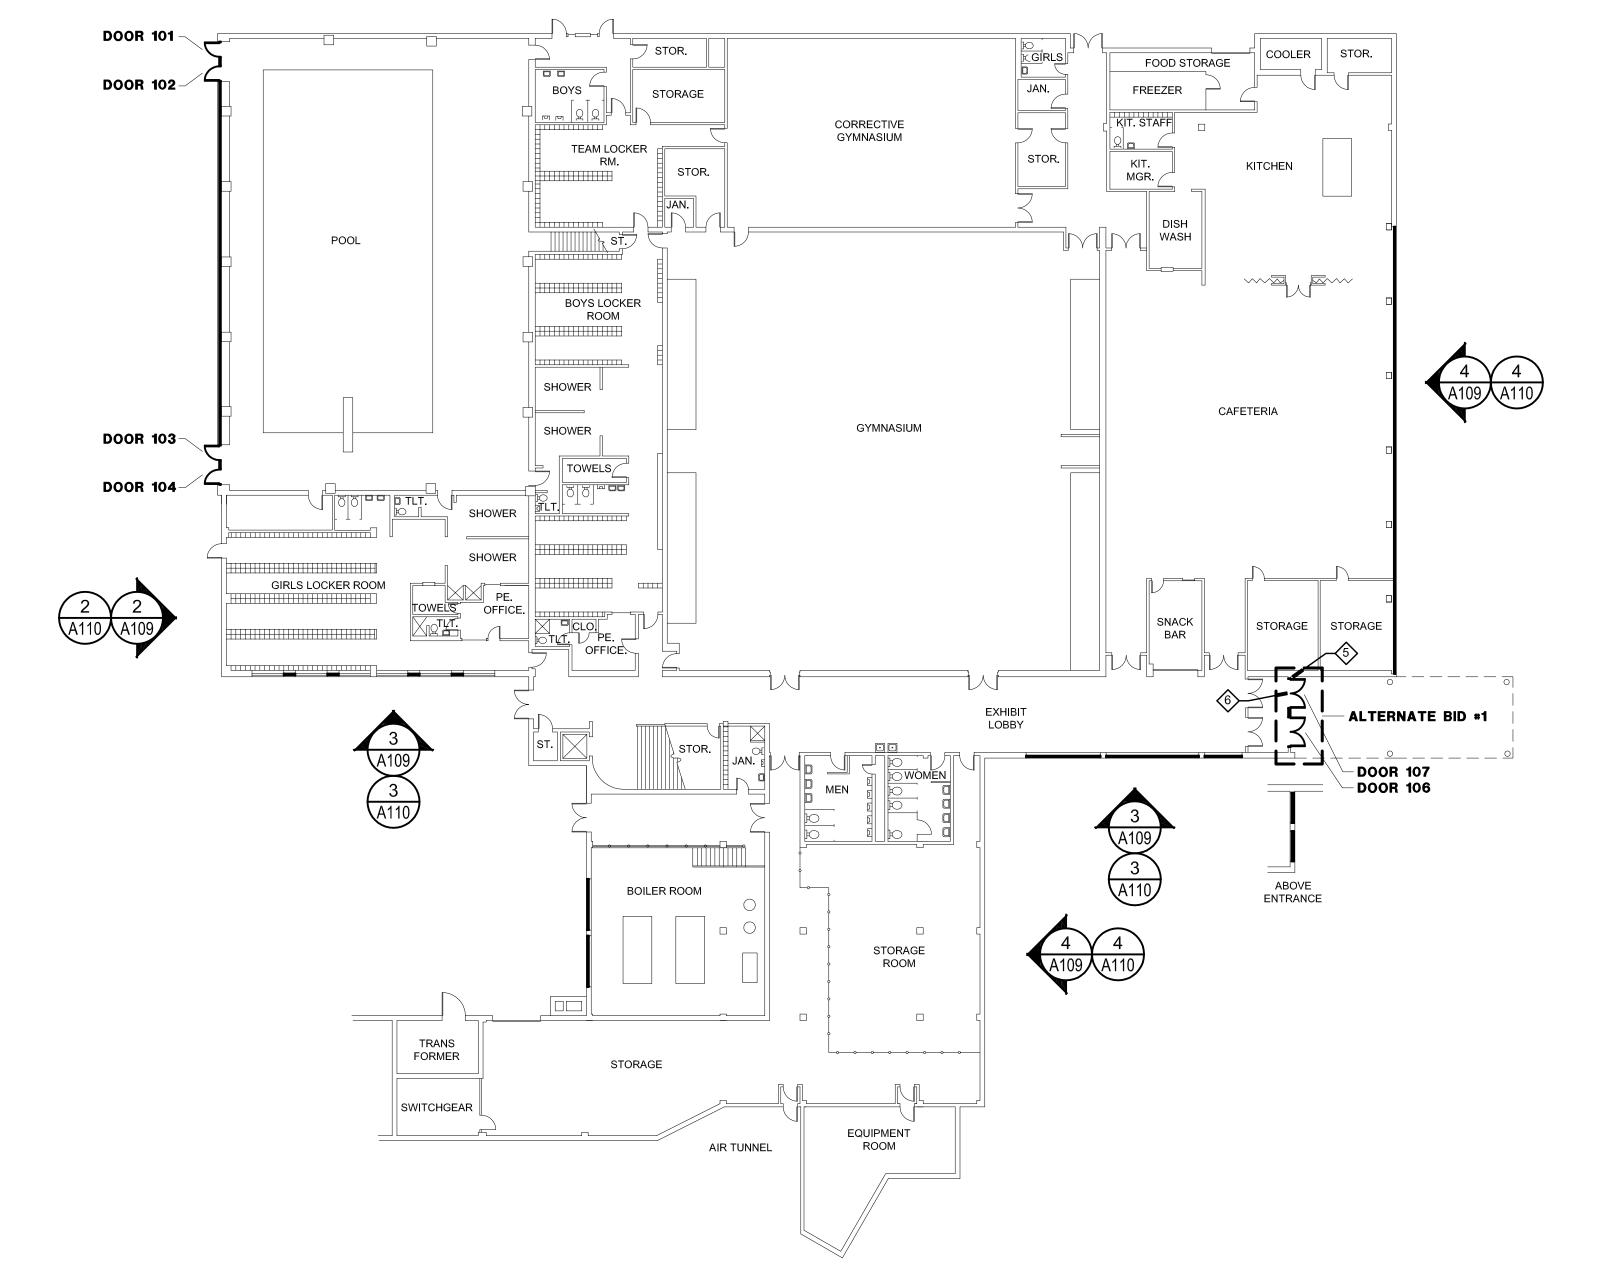
- PROVIDE ROLLER SHADES, OUTSIDE MOUNT ON PLASTER OR STEEL HEAD OF WINDOW ADJACENT TO WINDOW FRAME. SEE SPECIFICATIONS
- PROVIDE ONE SHADE PER SECTION ON ELEVATIONS. EACH VERTICAL DIVISION DESIGNATES A NEW SECTION. PROVIDE SHADES ON ALL GL-1 WINDOW SECTIONS UNLESS NOTED OTHERWISE. NO SHADES ON LOBBY/CORRIDOR/VESTIBULE/STAIR
- WINDOWS. PROVIDE SHADES ON ALL GL-2 WINDOW SECTIONS UNLESS NOTED OTHERWISE. NO SHADES FOR POOL, LOCKER ROOMS, TOILET ROOMS AND BOILER ROOM WINDOWS.
- NO SHADES ON GL-3 PANELS.
- FIELD VERIFY ALL WINDOW MEASUREMENTS PRIOR TO ORDERING SHADES.


GENERAL NOTES

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- PROVIDE BACKER ROD AND SEALANT AROUND PERIMETER OF NEW WINDOW AND ENTRANCE FRAMES - EACH SIDE OF FRAMES.
- CONTRACTOR IS RESPONSIBLE FOR ADDING STRUCTURAL REINFORCEMENT AS REQUIRED TO MEET STRUCTURAL LOADING FOR ALL WINDOW TYPES.
- WINDOWS SHALL OPEN AS FAR AS POSSIBLE. AT END OF PROJECT THE OWNER/ARCHITECT SHALL DETERMINE WHICH OPERABLE WINDOWS WILL REQUIRE A 4" MAXIMUM OPENING.
- PROVIDE A PROPER CAULK JOINT BETWEEN A/C UNITS AND METAL
- PROVIDE TREATED WOOD SHIMS AND BLOCKING AS REQUIRED FOR WINDOW INSTALLATIONS. APPLY A COATING TO THE WOOD BLOCKING SO AS TO NOT CHEMICALLY REACT WITH THE
- CONTRACTOR TO RESTORE ANY DISTURBED GRASS AREAS WITH SEED BACK TO ORIGINAL CONDITIONS AFTER WORK IS COMPLETE.
- ALL WINDOWS TO BE NON-OPERABLE EXCEPT WINDOW TYPE W8 AND WINDOW TYPE W24.
- CONTRACTOR TO VERIFY EXACT LOCATIONS AND SIZES OF AIR CONDITIONER UNITS IN NEW WINDOW SYSTEM WITH OWNER.
- 0. LINTELS AT WINDOWS AND ENTRANCES TO BE PAINTED THE SAME COLOR AS WINDOWS.
- 1. CONTRACTOR TO PROVIDE INTERIOR METAL TRIM AT FLOORS, WALLS AND CEILINGS AS REQUIRED TO COVER ANY EXPOSED CONSTRUCTION WHETHER SHOWN ON DETAILS OR NOT.
- 12. INSULATED METAL PANEL COLOR TO MATCH FRAMING COLOR. 13. CAULK COLOR TO MATCH FRAMING COLOR.

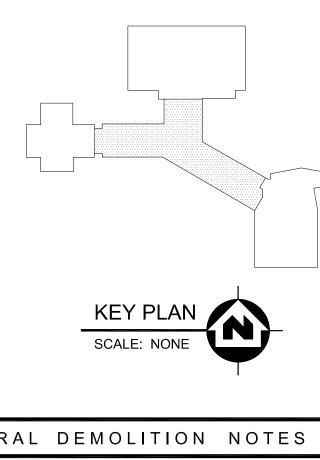
RENOVATION KEY NOTES

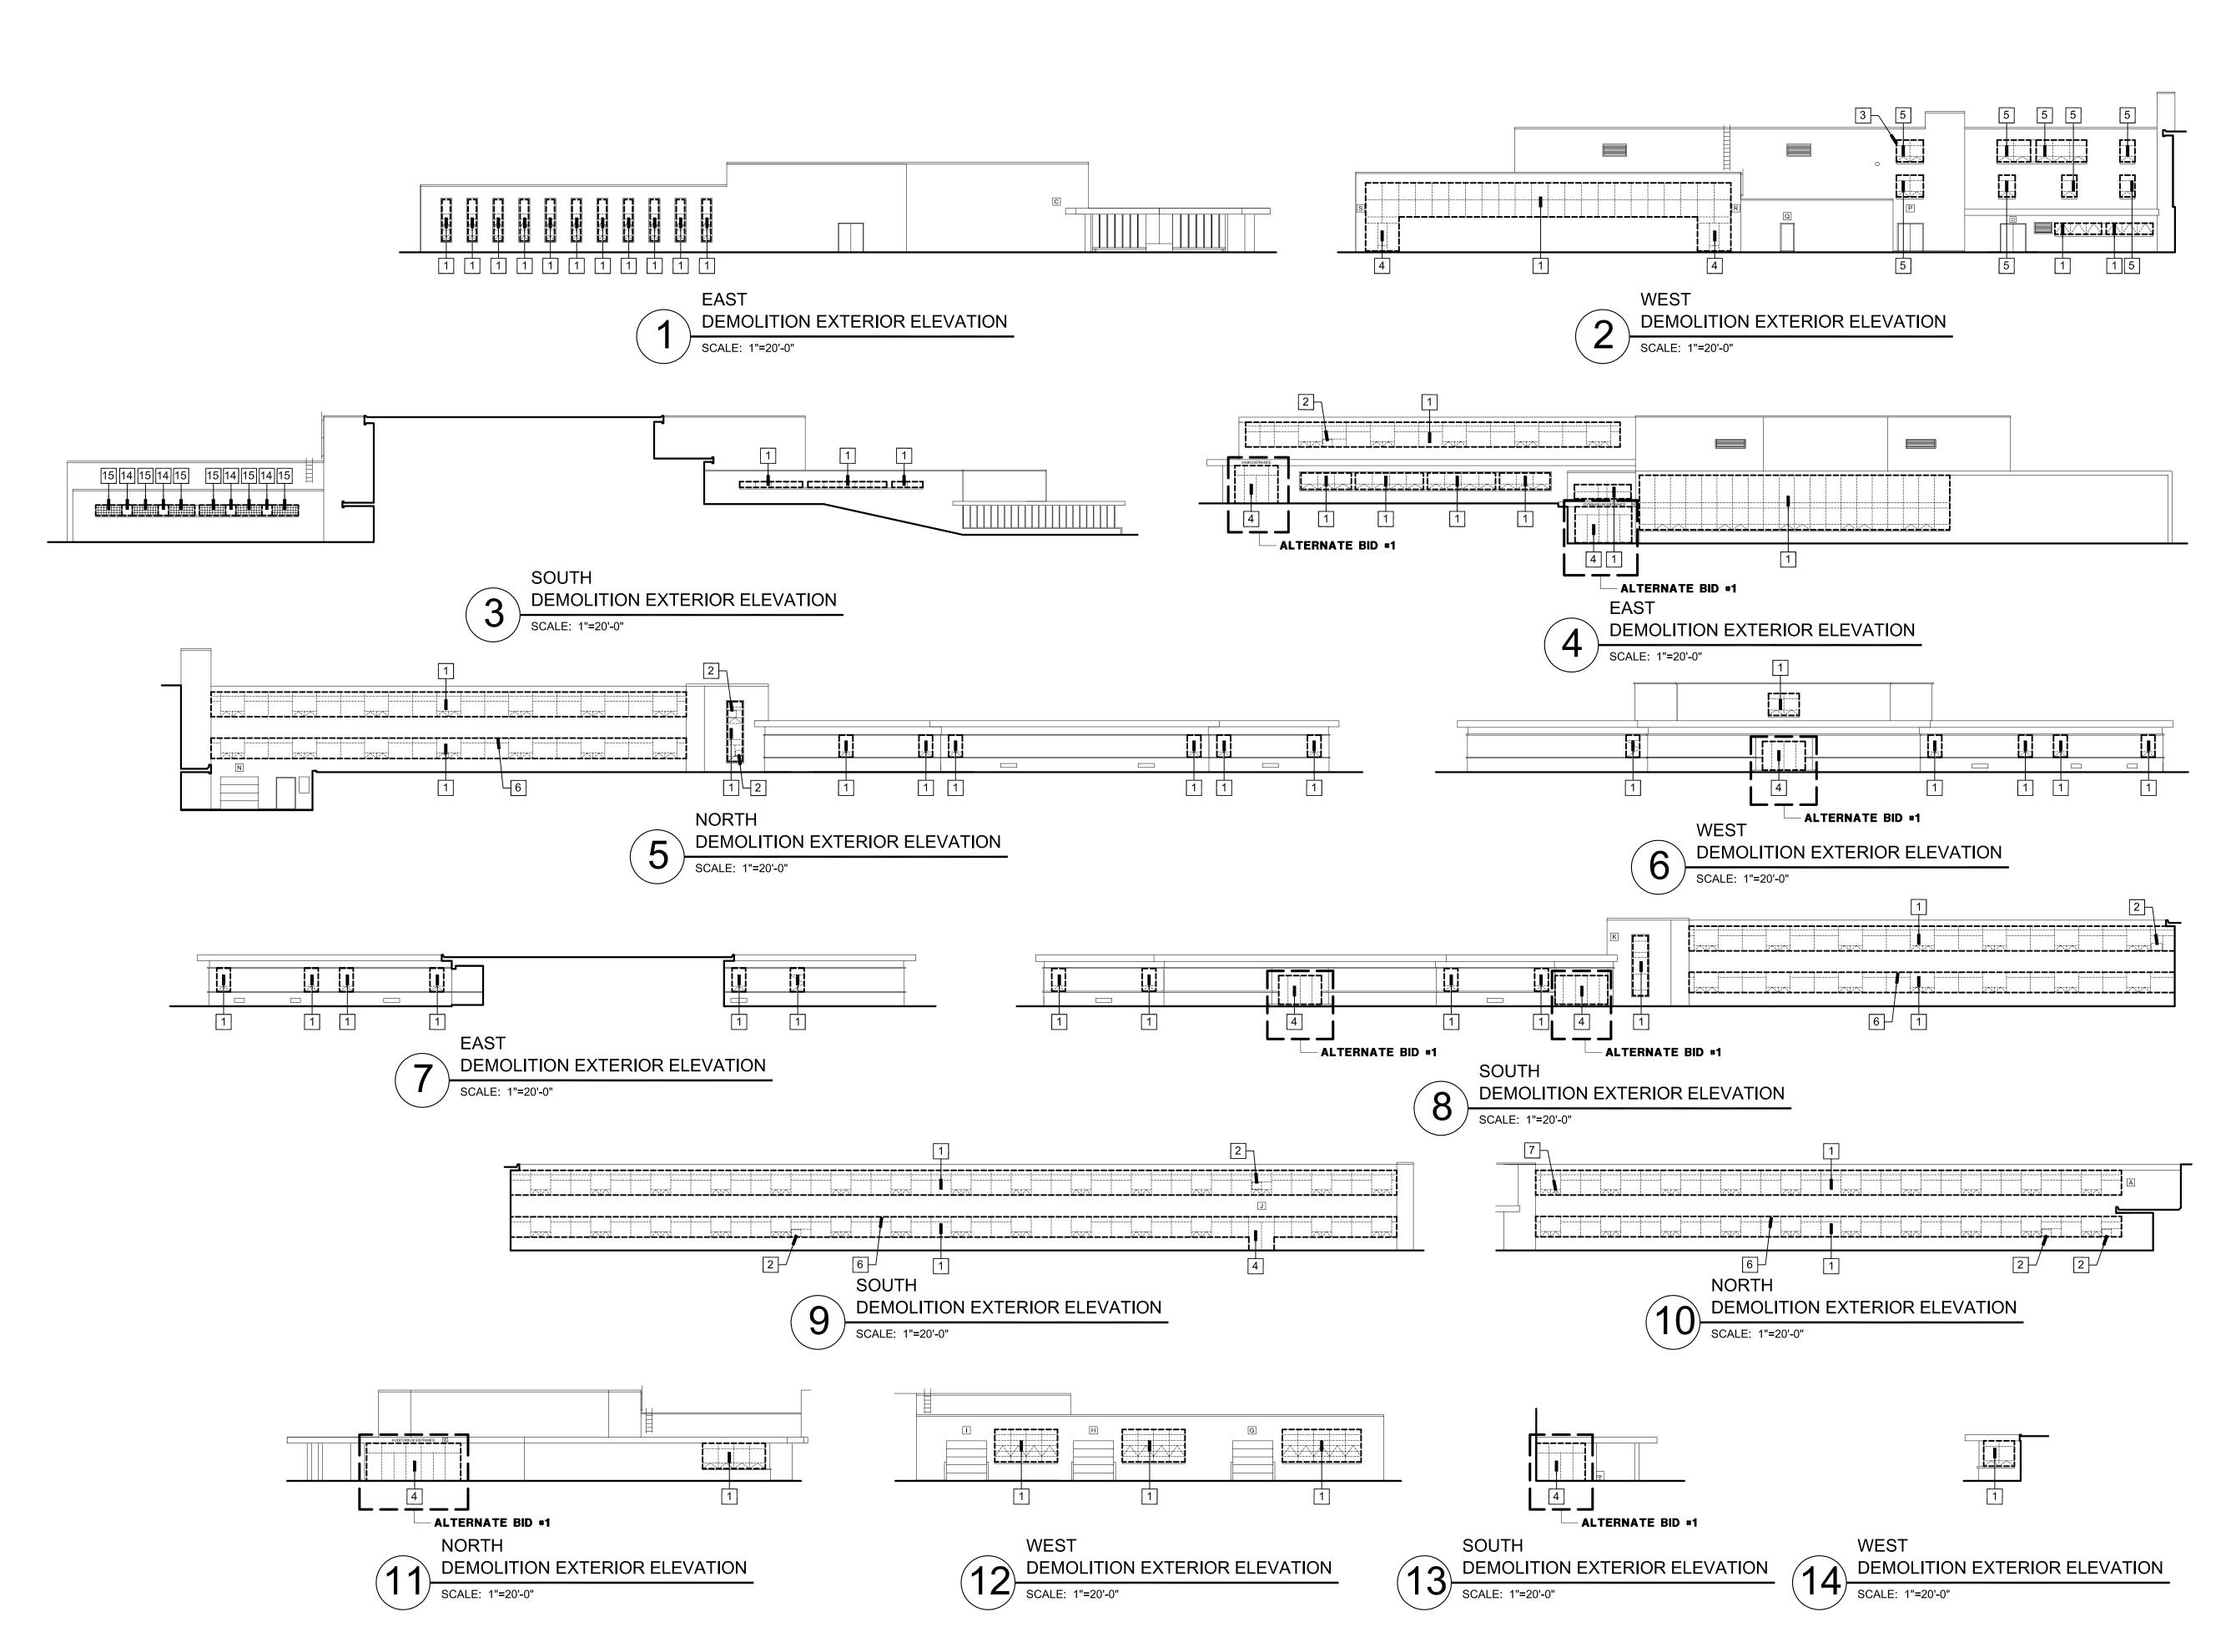- 1) INSTALL NEW ALUMINUM WINDOW SYSTEM AND GLAZING COMPLETE.
- (2) INSTALL NEW ALUMINUM ENTRANCE SYSTEM AND GLAZING COMPLETE.
- 3 INSTALL EXISTING AIR CONDITIONER IN NEW INSULATED METAL PANEL (GL-3). REINSTALL EXISTING A/C SUPPORTS. INSTALL SEALANT BETWEEN THE PANEL AND THE A/C UNIT TO MATCH PANEL COLOR.
- 4 INSTALL NEW CAULK AROUND PERIMETER OF GLASS BLOCK.
- 5 REINSTALL SALVAGED FOB CARD DEVICE AND PROVIDE POWER
- CONNECTION AS REQUIRED TO NEW ELECTRIC STRIKE. 6 REINSTALL SALVAGED MOTION DETECTOR AND PROVIDE POWER CONNECTION AS REQUIRED.
- REINSTALL SALVAGED DOOR CHIME AND PROVIDE POWER CONNECTION AS REQUIRED.
- REINSTALL SALVAGED INTERCOM STATION AND PROVIDE POWER CONNECTION AS REQUIRED.
- (9) THIS WINDOW TO BE A MOCK-UP WINDOW. SEE SPECIFICATIONS.

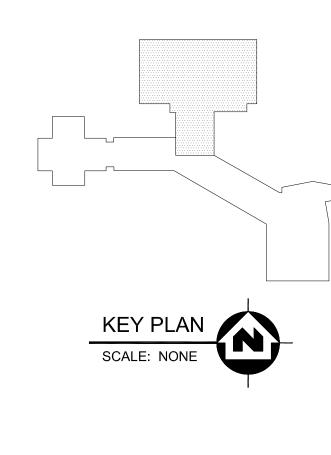

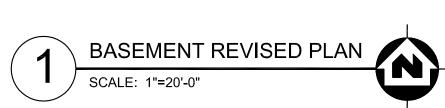

A107

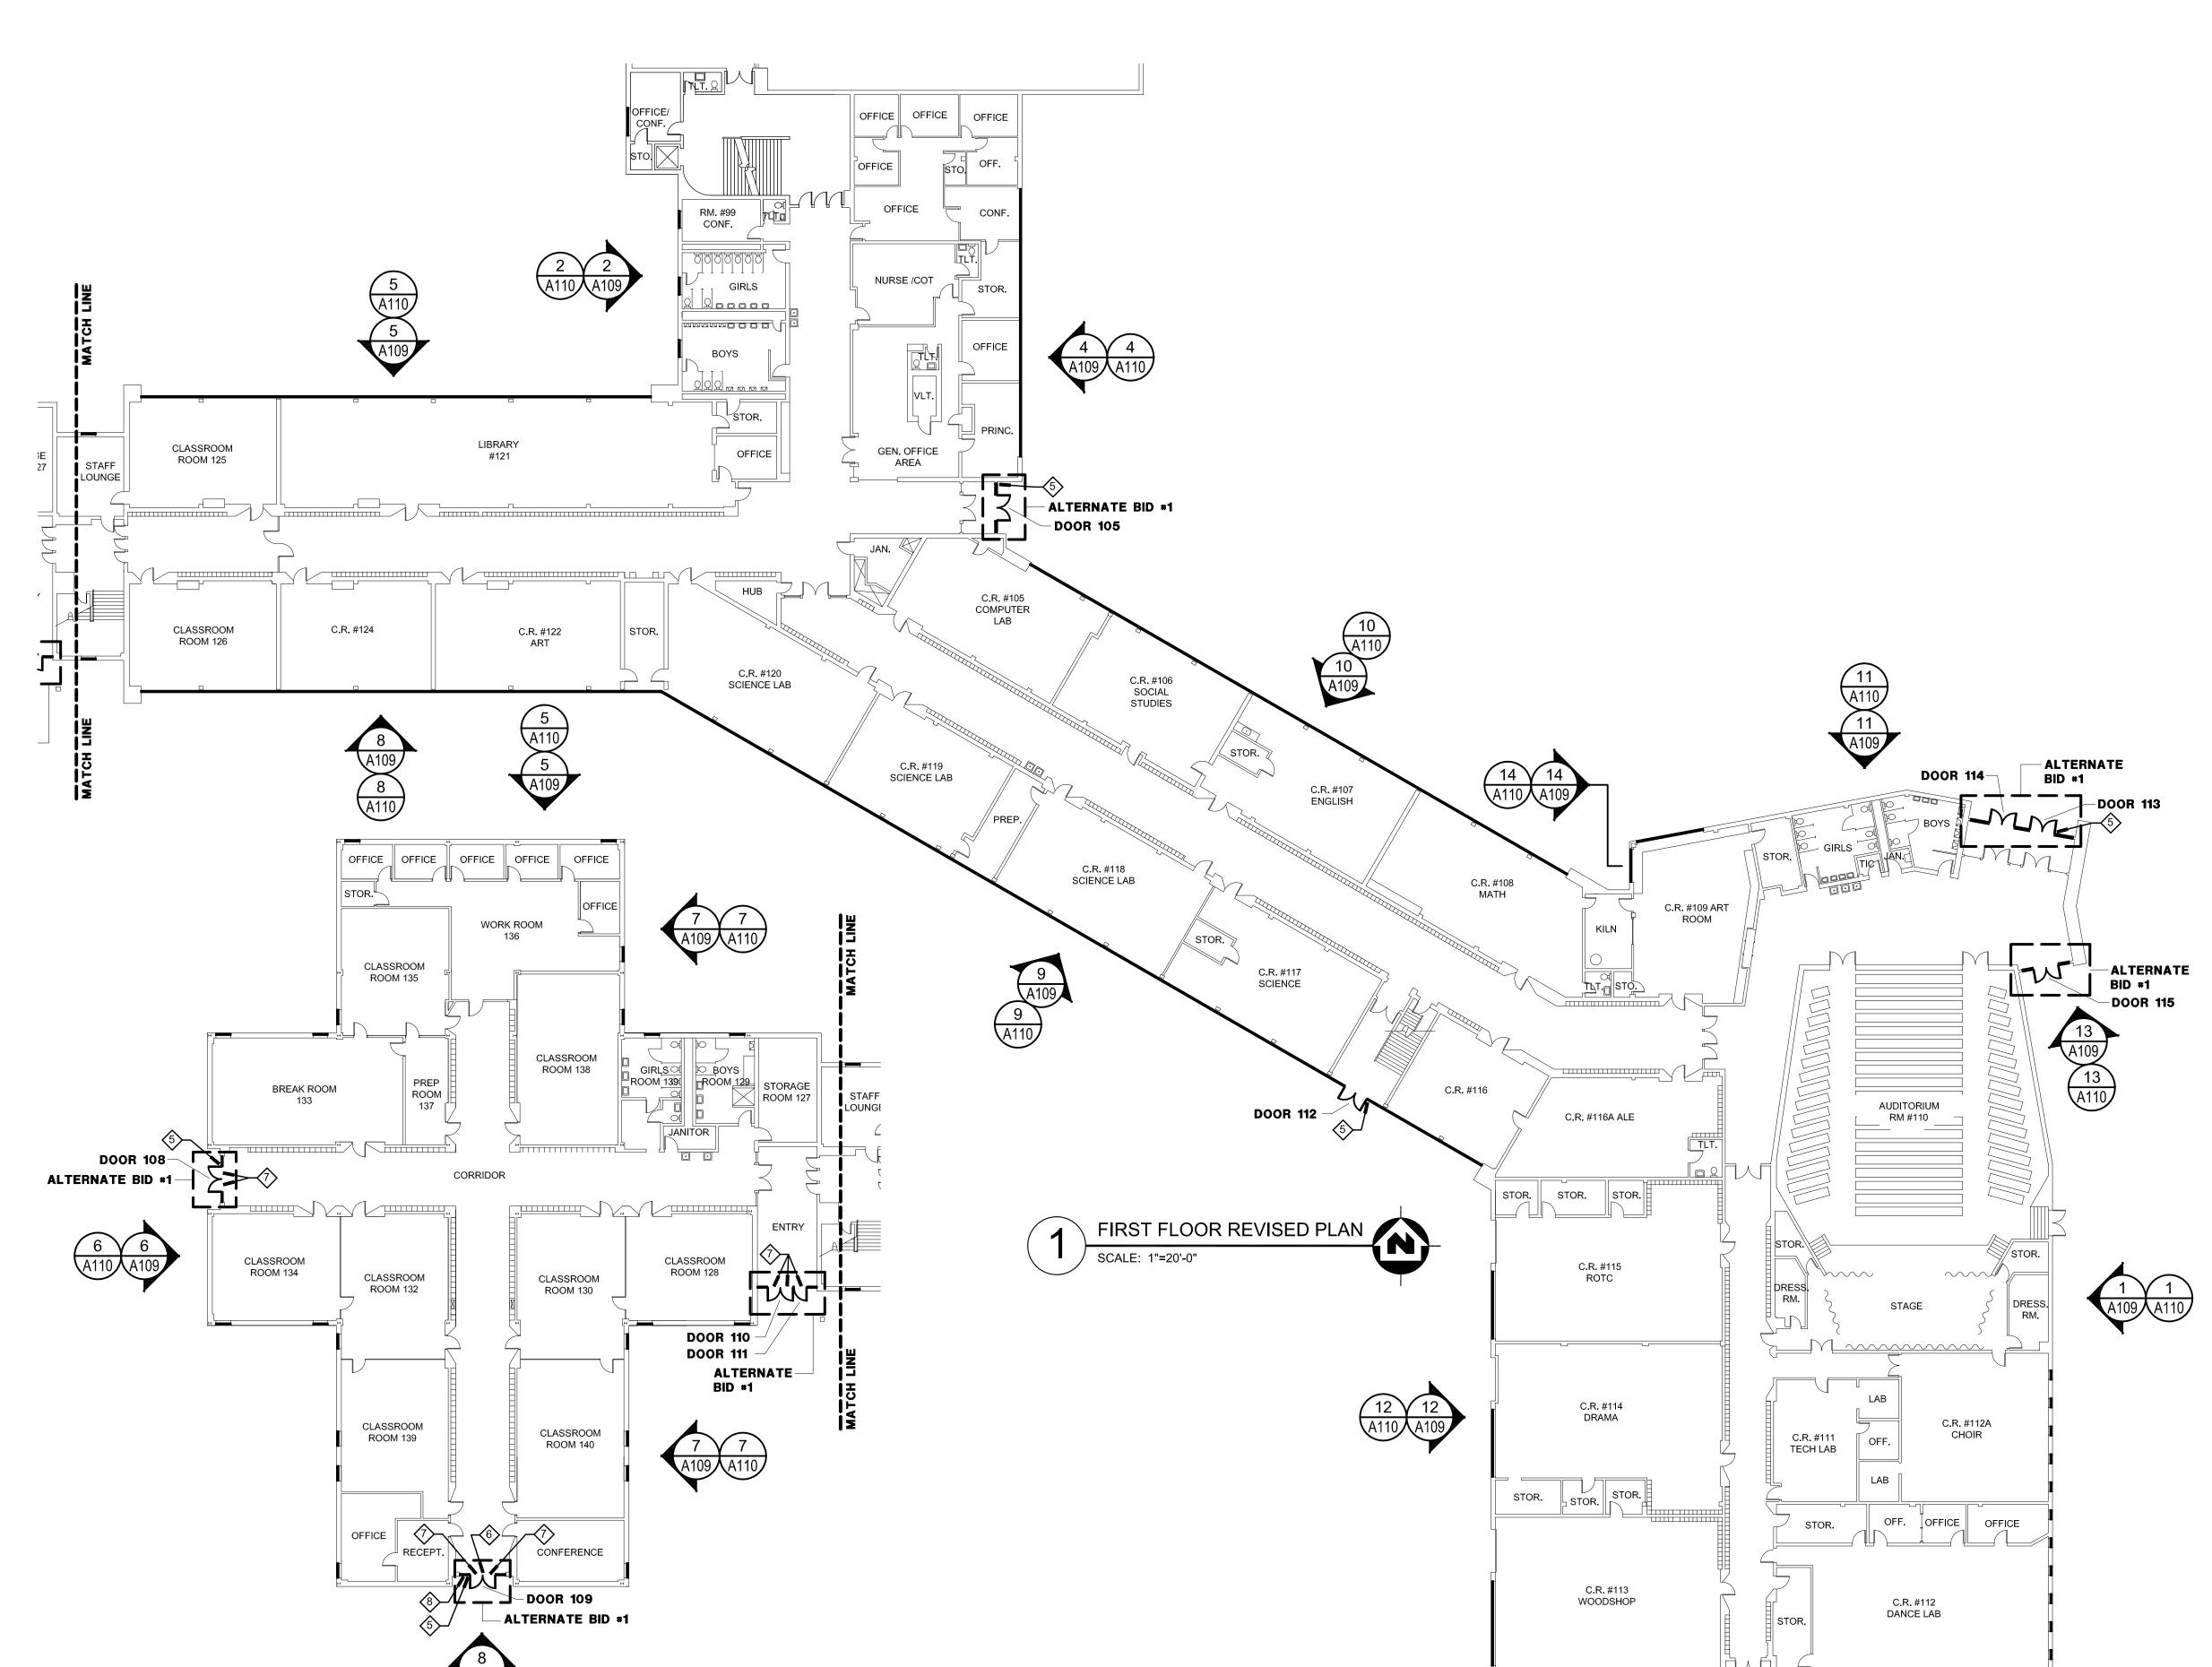

FIRST FLOOR REVISED PLAN

SCALE: 1"=20'-0"



DIVISION DESIGNATES A NEW SECTION.


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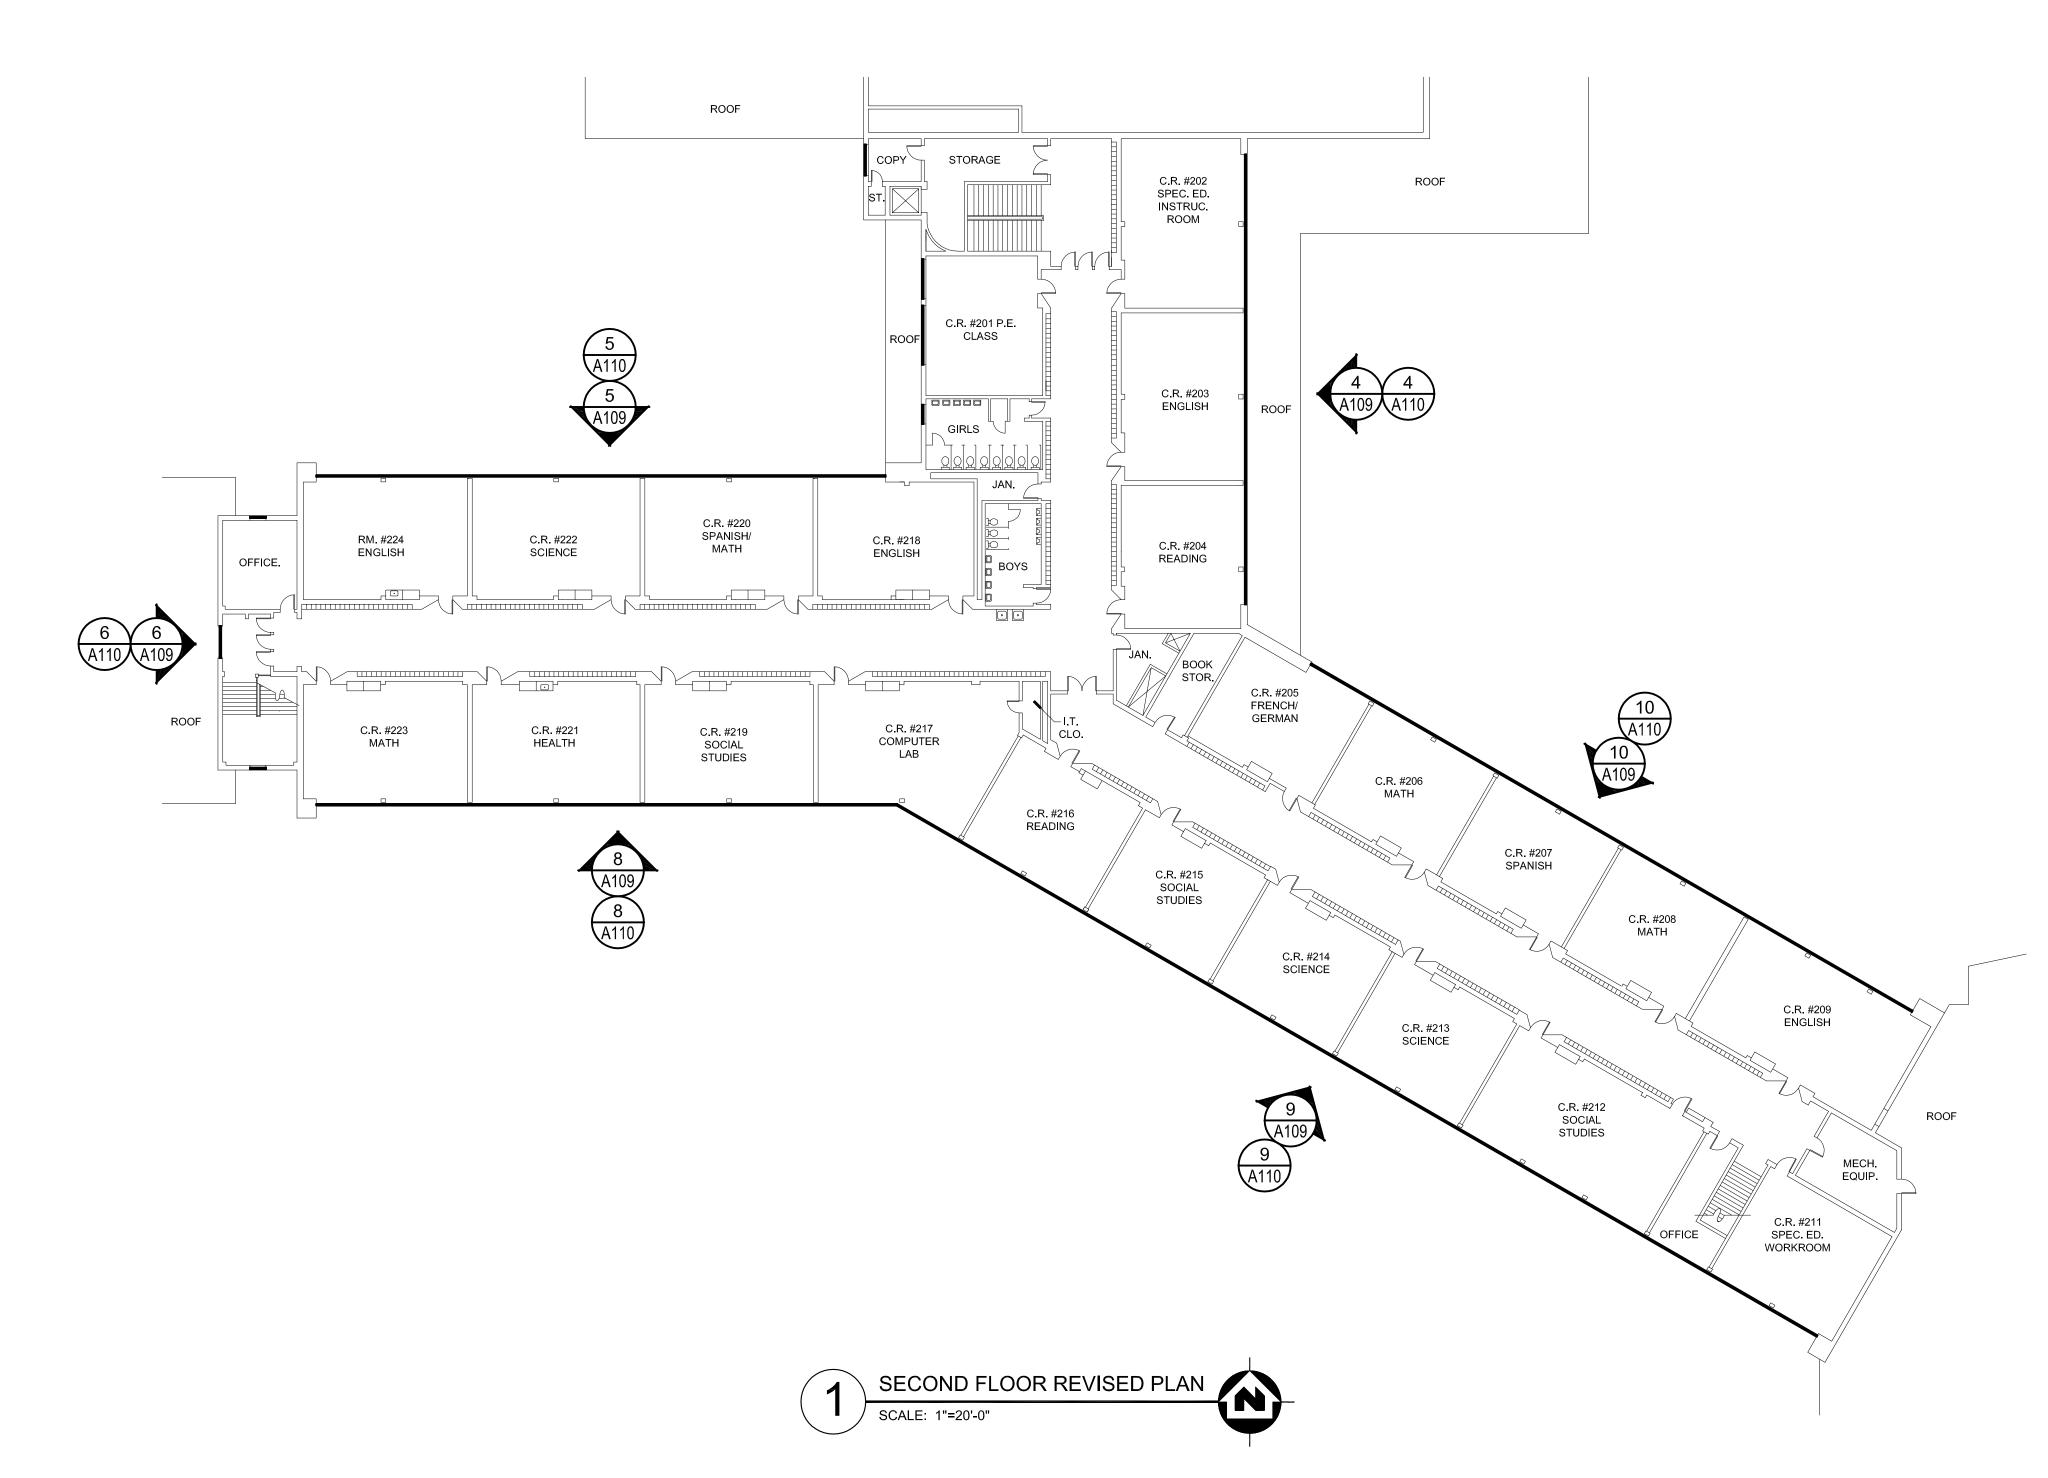
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- 1 INSTALL NEW ALUMINUM WINDOW SYSTEM AND GLAZING COMPLETE.
- (2) INSTALL NEW ALUMINUM ENTRANCE SYSTEM AND GLAZING COMPLETE.
- 3 INSTALL EXISTING AIR CONDITIONER IN NEW INSULATED METAL PANEL (GL-3). REINSTALL EXISTING A/C SUPPORTS. INSTALL SEALANT BETWEEN THE PANEL AND THE A/C UNIT TO MATCH PANEL COLOR.
- 4 INSTALL NEW CAULK AROUND PERIMETER OF GLASS BLOCK.
- (5) REINSTALL SALVAGED FOB CARD DEVICE AND PROVIDE POWER
- CONNECTION AS REQUIRED TO NEW ELECTRIC STRIKE. REINSTALL SALVAGED MOTION DETECTOR AND PROVIDE POWER CONNECTION AS REQUIRED.
- REINSTALL SALVAGED DOOR CHIME AND PROVIDE POWER CONNECTION AS REQUIRED.
- 8 REINSTALL SALVAGED INTERCOM STATION AND PROVIDE POWER CONNECTION AS REQUIRED. THIS WINDOW TO BE A MOCK-UP WINDOW. SEE SPECIFICATIONS.





WINDOW SHADE GENERAL NOTES

- PROVIDE ROLLER SHADES, OUTSIDE MOUNT ON PLASTER OR STEEL HEAD OF WINDOW ADJACENT TO WINDOW FRAME. SEE SPECIFICATIONS
- PROVIDE ONE SHADE PER SECTION ON ELEVATIONS. EACH VERTICAL DIVISION DESIGNATES A NEW SECTION.
- PROVIDE SHADES ON ALL GL-1 WINDOW SECTIONS UNLESS NOTED OTHERWISE. NO SHADES ON LOBBY/CORRIDOR/VESTIBULE/STAIR
- PROVIDE SHADES ON ALL GL-2 WINDOW SECTIONS UNLESS NOTED OTHERWISE. NO SHADES FOR POOL, LOCKER ROOMS, TOILET ROOMS AND BOILER ROOM WINDOWS.
- NO SHADES ON GL-3 PANELS.
- FIELD VERIFY ALL WINDOW MEASUREMENTS PRIOR TO ORDERING

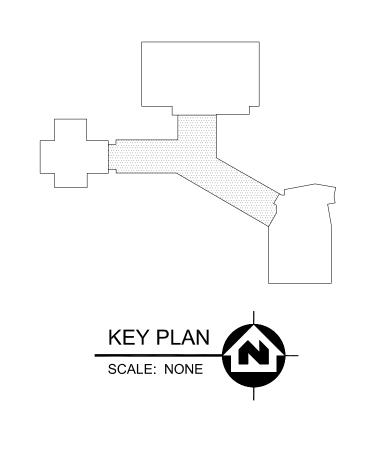GENERAL NOTES


- THE CONTRACTOR SHALL VERIFY ALL EXISTING WINDOW DIMENSIONS PRIOR TO BIDDING. THE DIMENSIONS ON THE DRAWING ARE +/-.
- PROVIDE BACKER ROD AND SEALANT AROUND PERIMETER OF NEW WINDOW AND ENTRANCE FRAMES - EACH SIDE OF FRAMES.
- CONTRACTOR IS RESPONSIBLE FOR ADDING STRUCTURAL REINFORCEMENT AS REQUIRED TO MEET STRUCTURAL LOADING FOR ALL WINDOW TYPES.
- WINDOWS SHALL OPEN AS FAR AS POSSIBLE. AT END OF PROJECT THE OWNER/ARCHITECT SHALL DETERMINE WHICH OPERABLE WINDOWS WILL REQUIRE A 4" MAXIMUM OPENING.
- PROVIDE A PROPER CAULK JOINT BETWEEN A/C UNITS AND METAL
- PROVIDE TREATED WOOD SHIMS AND BLOCKING AS REQUIRED FOR WINDOW INSTALLATIONS. APPLY A COATING TO THE WOOD BLOCKING SO AS TO NOT CHEMICALLY REACT WITH THE ALUMINUM.
- CONTRACTOR TO RESTORE ANY DISTURBED GRASS AREAS WITH SEED BACK TO ORIGINAL CONDITIONS AFTER WORK IS COMPLETE.
- ALL WINDOWS TO BE NON-OPERABLE EXCEPT WINDOW TYPE W8 AND WINDOW TYPE W24.
- CONTRACTOR TO VERIFY EXACT LOCATIONS AND SIZES OF AIR
- CONDITIONER UNITS IN NEW WINDOW SYSTEM WITH OWNER.
- 10. LINTELS AT WINDOWS AND ENTRANCES TO BE PAINTED THE SAME COLOR AS WINDOWS.
- 1. CONTRACTOR TO PROVIDE INTERIOR METAL TRIM AT FLOORS, WALLS AND CEILINGS AS REQUIRED TO COVER ANY EXPOSED CONSTRUCTION WHETHER SHOWN ON DETAILS OR NOT.
- 12. INSULATED METAL PANEL COLOR TO MATCH FRAMING COLOR.
- 13. CAULK COLOR TO MATCH FRAMING COLOR.


RENOVATION KEY NOTES

- 1) INSTALL NEW ALUMINUM WINDOW SYSTEM AND GLAZING COMPLETE.
- (2) INSTALL NEW ALUMINUM ENTRANCE SYSTEM AND GLAZING COMPLETE.
- 3 INSTALL EXISTING AIR CONDITIONER IN NEW INSULATED METAL PANEL (GL-3). REINSTALL EXISTING A/C SUPPORTS. INSTALL SEALANT
- BETWEEN THE PANEL AND THE A/C UNIT TO MATCH PANEL COLOR.
- 4 INSTALL NEW CAULK AROUND PERIMETER OF GLASS BLOCK.
- 5 REINSTALL SALVAGED FOB CARD DEVICE AND PROVIDE POWER CONNECTION AS REQUIRED TO NEW ELECTRIC STRIKE.
- 6 REINSTALL SALVAGED MOTION DETECTOR AND PROVIDE POWER CONNECTION AS REQUIRED.

8 REINSTALL SALVAGED INTERCOM STATION AND PROVIDE POWER

- 7 REINSTALL SALVAGED DOOR CHIME AND PROVIDE POWER CONNECTION AS REQUIRED.
- CONNECTION AS REQUIRED. 9 THIS WINDOW TO BE A MOCK-UP WINDOW. SEE SPECIFICATIONS.

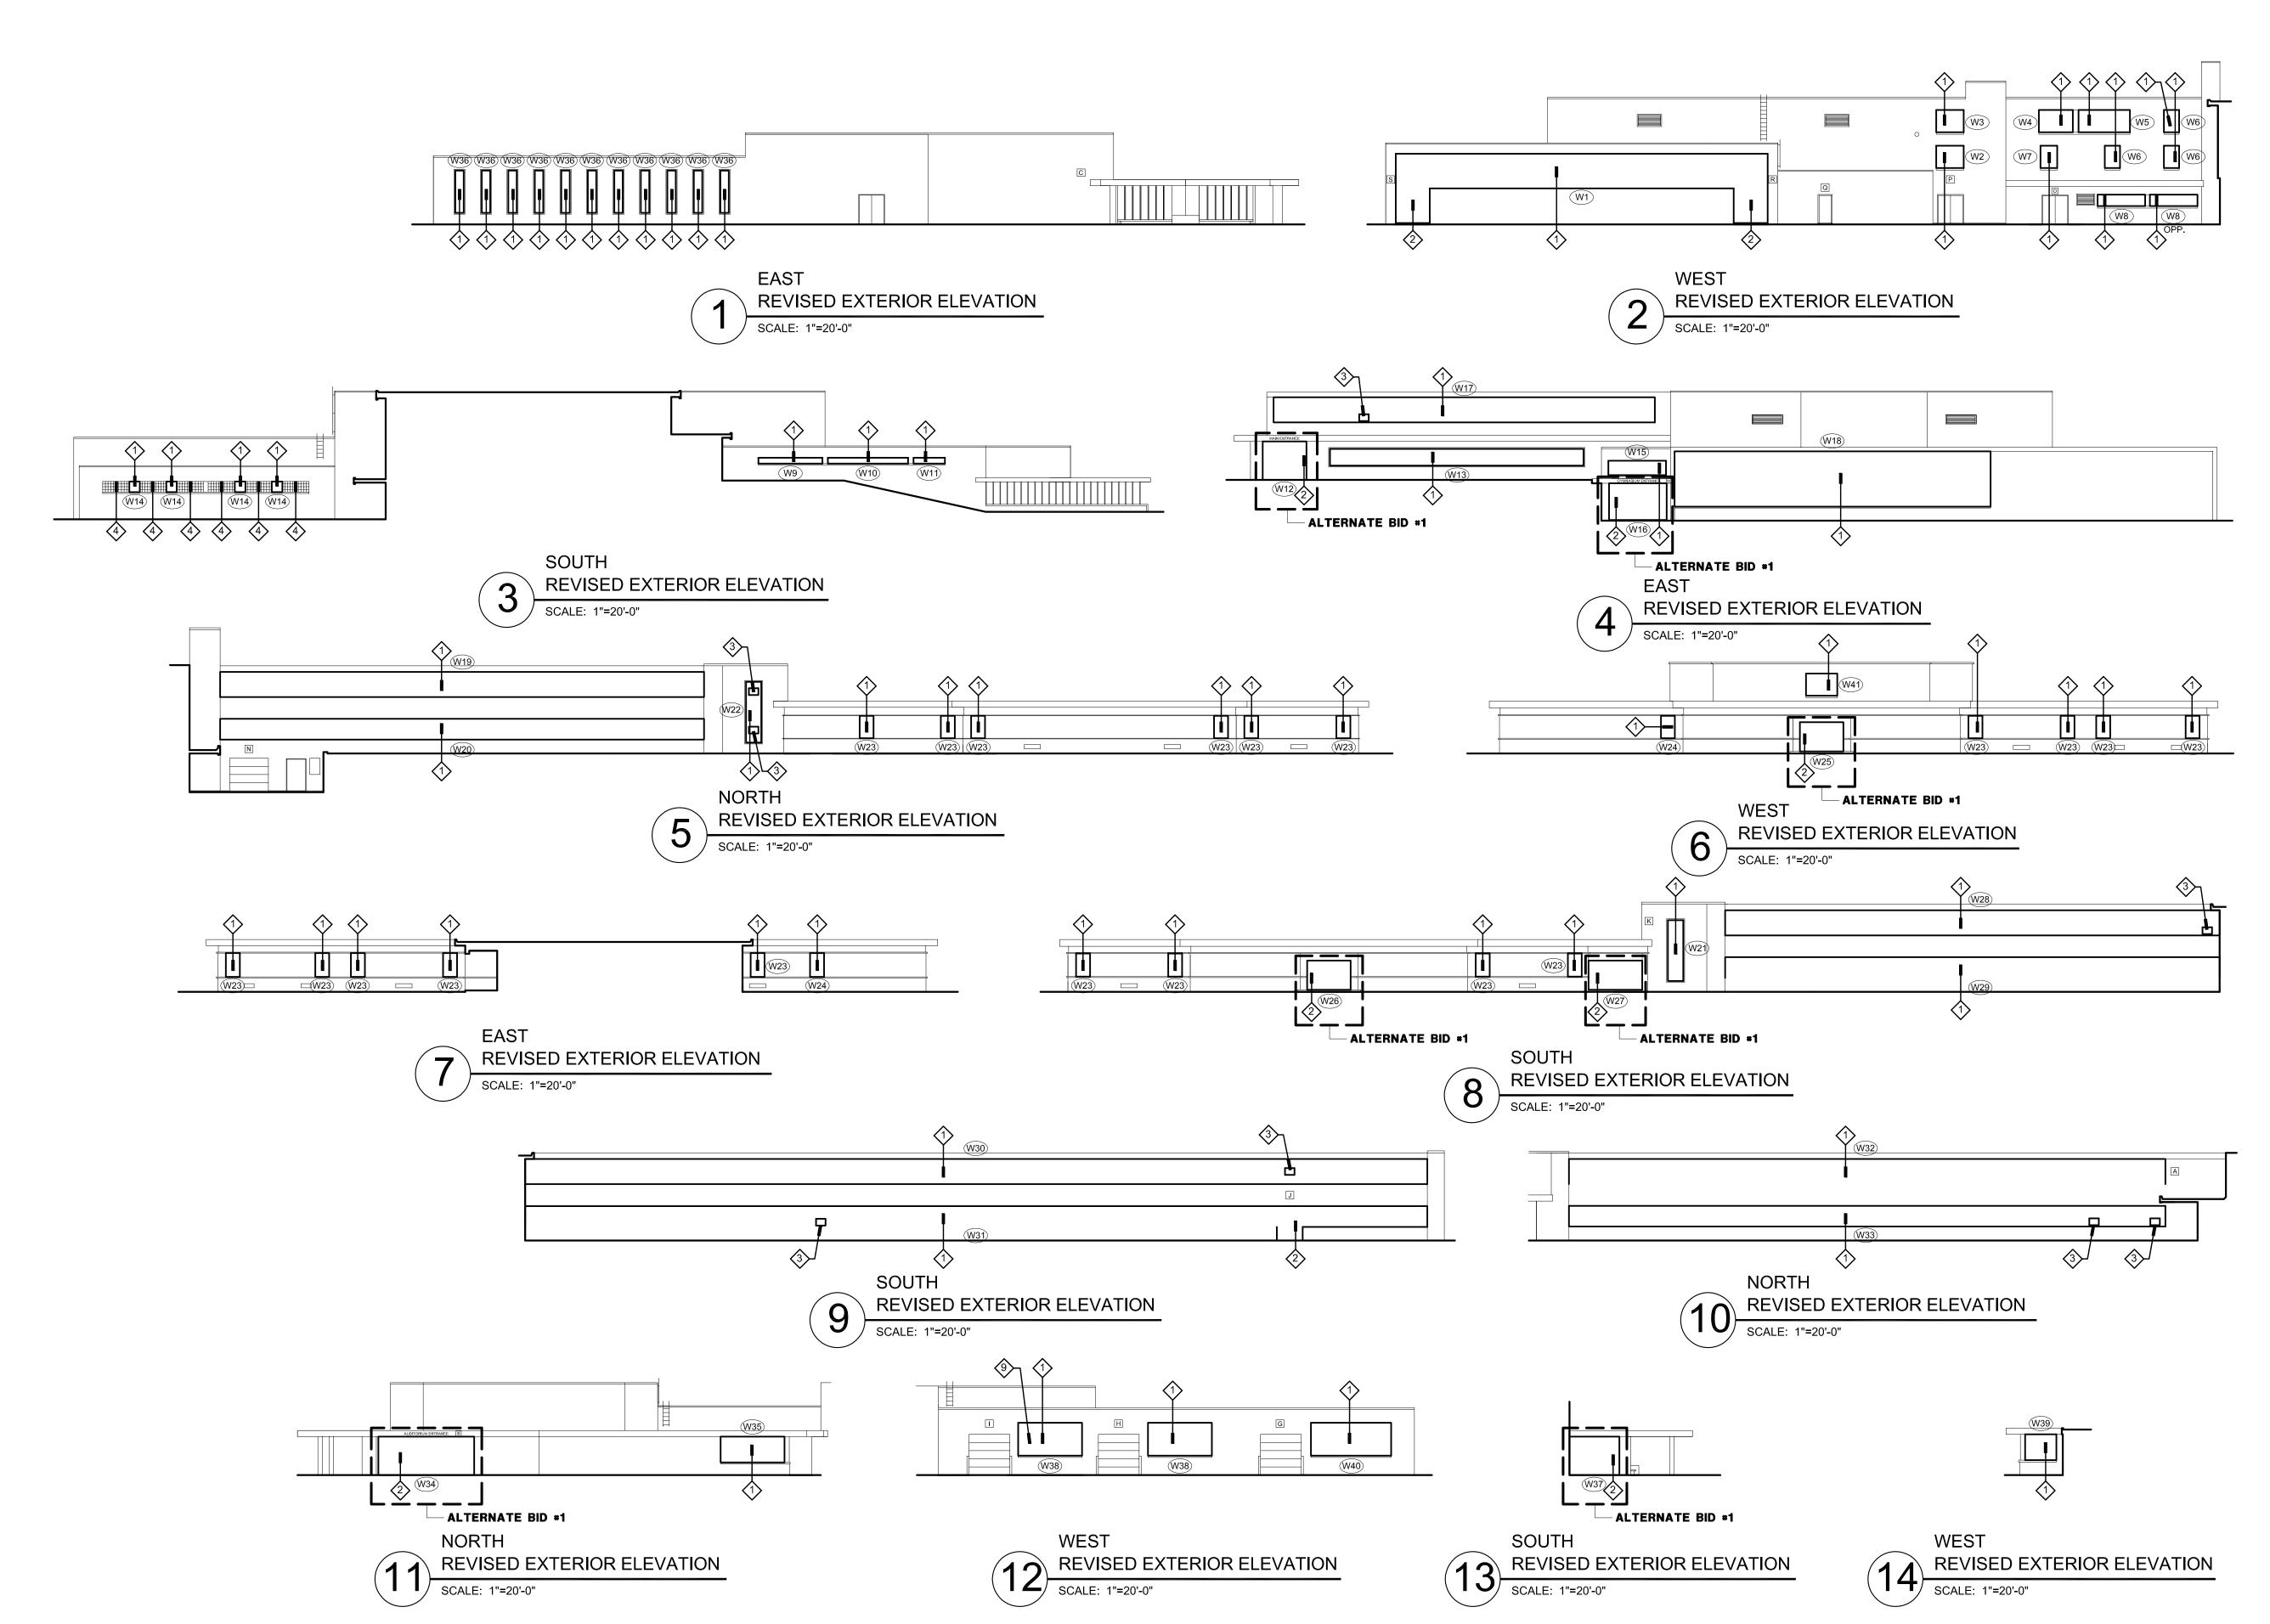

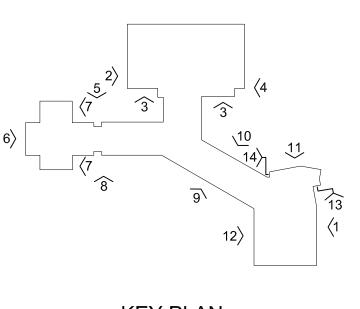

KEY PLAN SCALE: NONE

WINDOW SHADE GENERAL NOTES

- PROVIDE ROLLER SHADES, OUTSIDE MOUNT ON PLASTER OR STEEL HEAD OF WINDOW ADJACENT TO WINDOW FRAME. SEE SPECIFICATIONS.
- PROVIDE ONE SHADE PER SECTION ON ELEVATIONS. EACH VERTICAL DIVISION DESIGNATES A NEW SECTION.
- PROVIDE SHADES ON ALL GL-1 WINDOW SECTIONS UNLESS NOTED OTHERWISE. NO SHADES ON LOBBY/CORRIDOR/VESTIBULE/STAIR
- PROVIDE SHADES ON ALL GL-2 WINDOW SECTIONS UNLESS NOTED OTHERWISE. NO SHADES FOR POOL, LOCKER ROOMS, TOILET ROOMS AND BOILER ROOM WINDOWS.
- NO SHADES ON GL-3 PANELS.
- FIELD VERIFY ALL WINDOW MEASUREMENTS PRIOR TO ORDERING

GENERAL NOTES

- THE CONTRACTOR SHALL VERIFY ALL EXISTING WINDOW DIMENSIONS PRIOR TO BIDDING. THE DIMENSIONS ON THE DRAWING ARE +/-.
- PROVIDE BACKER ROD AND SEALANT AROUND PERIMETER OF NEW
- WINDOW AND ENTRANCE FRAMES EACH SIDE OF FRAMES. CONTRACTOR IS RESPONSIBLE FOR ADDING STRUCTURAL

REINFORCEMENT AS REQUIRED TO MEET STRUCTURAL LOADING

- FOR ALL WINDOW TYPES. WINDOWS SHALL OPEN AS FAR AS POSSIBLE. AT END OF PROJECT
- THE OWNER/ARCHITECT SHALL DETERMINE WHICH OPERABLE WINDOWS WILL REQUIRE A 4" MAXIMUM OPENING.
- PROVIDE A PROPER CAULK JOINT BETWEEN A/C UNITS AND METAL
- PROVIDE TREATED WOOD SHIMS AND BLOCKING AS REQUIRED FOR WINDOW INSTALLATIONS. APPLY A COATING TO THE WOOD BLOCKING SO AS TO NOT CHEMICALLY REACT WITH THE ALUMINUM.
- CONTRACTOR TO RESTORE ANY DISTURBED GRASS AREAS WITH SEED BACK TO ORIGINAL CONDITIONS AFTER WORK IS COMPLETE.
- ALL WINDOWS TO BE NON-OPERABLE EXCEPT WINDOW TYPE W8 AND WINDOW TYPE W24.
- CONTRACTOR TO VERIFY EXACT LOCATIONS AND SIZES OF AIR
- CONDITIONER UNITS IN NEW WINDOW SYSTEM WITH OWNER.
- 0. LINTELS AT WINDOWS AND ENTRANCES TO BE PAINTED THE SAME COLOR AS WINDOWS.
- CONTRACTOR TO PROVIDE INTERIOR METAL TRIM AT FLOORS, WALLS AND CEILINGS AS REQUIRED TO COVER ANY EXPOSED CONSTRUCTION WHETHER SHOWN ON DETAILS OR NOT.
- 12. INSULATED METAL PANEL COLOR TO MATCH FRAMING COLOR. CAULK COLOR TO MATCH FRAMING COLOR.

RENOVATION KEY NOTES

- (1) INSTALL NEW ALUMINUM WINDOW SYSTEM AND GLAZING COMPLETE.
- INSTALL NEW ALUMINUM ENTRANCE SYSTEM AND GLAZING COMPLETE.
- 3 INSTALL EXISTING AIR CONDITIONER IN NEW INSULATED METAL PANEL
- (GL-3). REINSTALL EXISTING A/C SUPPORTS. INSTALL SEALANT BETWEEN THE PANEL AND THE A/C UNIT TO MATCH PANEL COLOR.
- $\langle 4 \rangle$ INSTALL NEW CAULK AROUND PERIMETER OF GLASS BLOCK.
- REINSTALL SALVAGED FOB CARD DEVICE AND PROVIDE POWER CONNECTION AS REQUIRED TO NEW ELECTRIC STRIKE.
- 6 REINSTALL SALVAGED MOTION DETECTOR AND PROVIDE POWER CONNECTION AS REQUIRED.
- REINSTALL SALVAGED DOOR CHIME AND PROVIDE POWER CONNECTION AS REQUIRED.
- REINSTALL SALVAGED INTERCOM STATION AND PROVIDE POWER CONNECTION AS REQUIRED.
- 9 THIS WINDOW TO BE A MOCK-UP WINDOW. SEE SPECIFICATIONS.



W6

W8 W8






REVISED EXTERIOR ELEVATIONS

SHEET NUMBER A110 OF

20

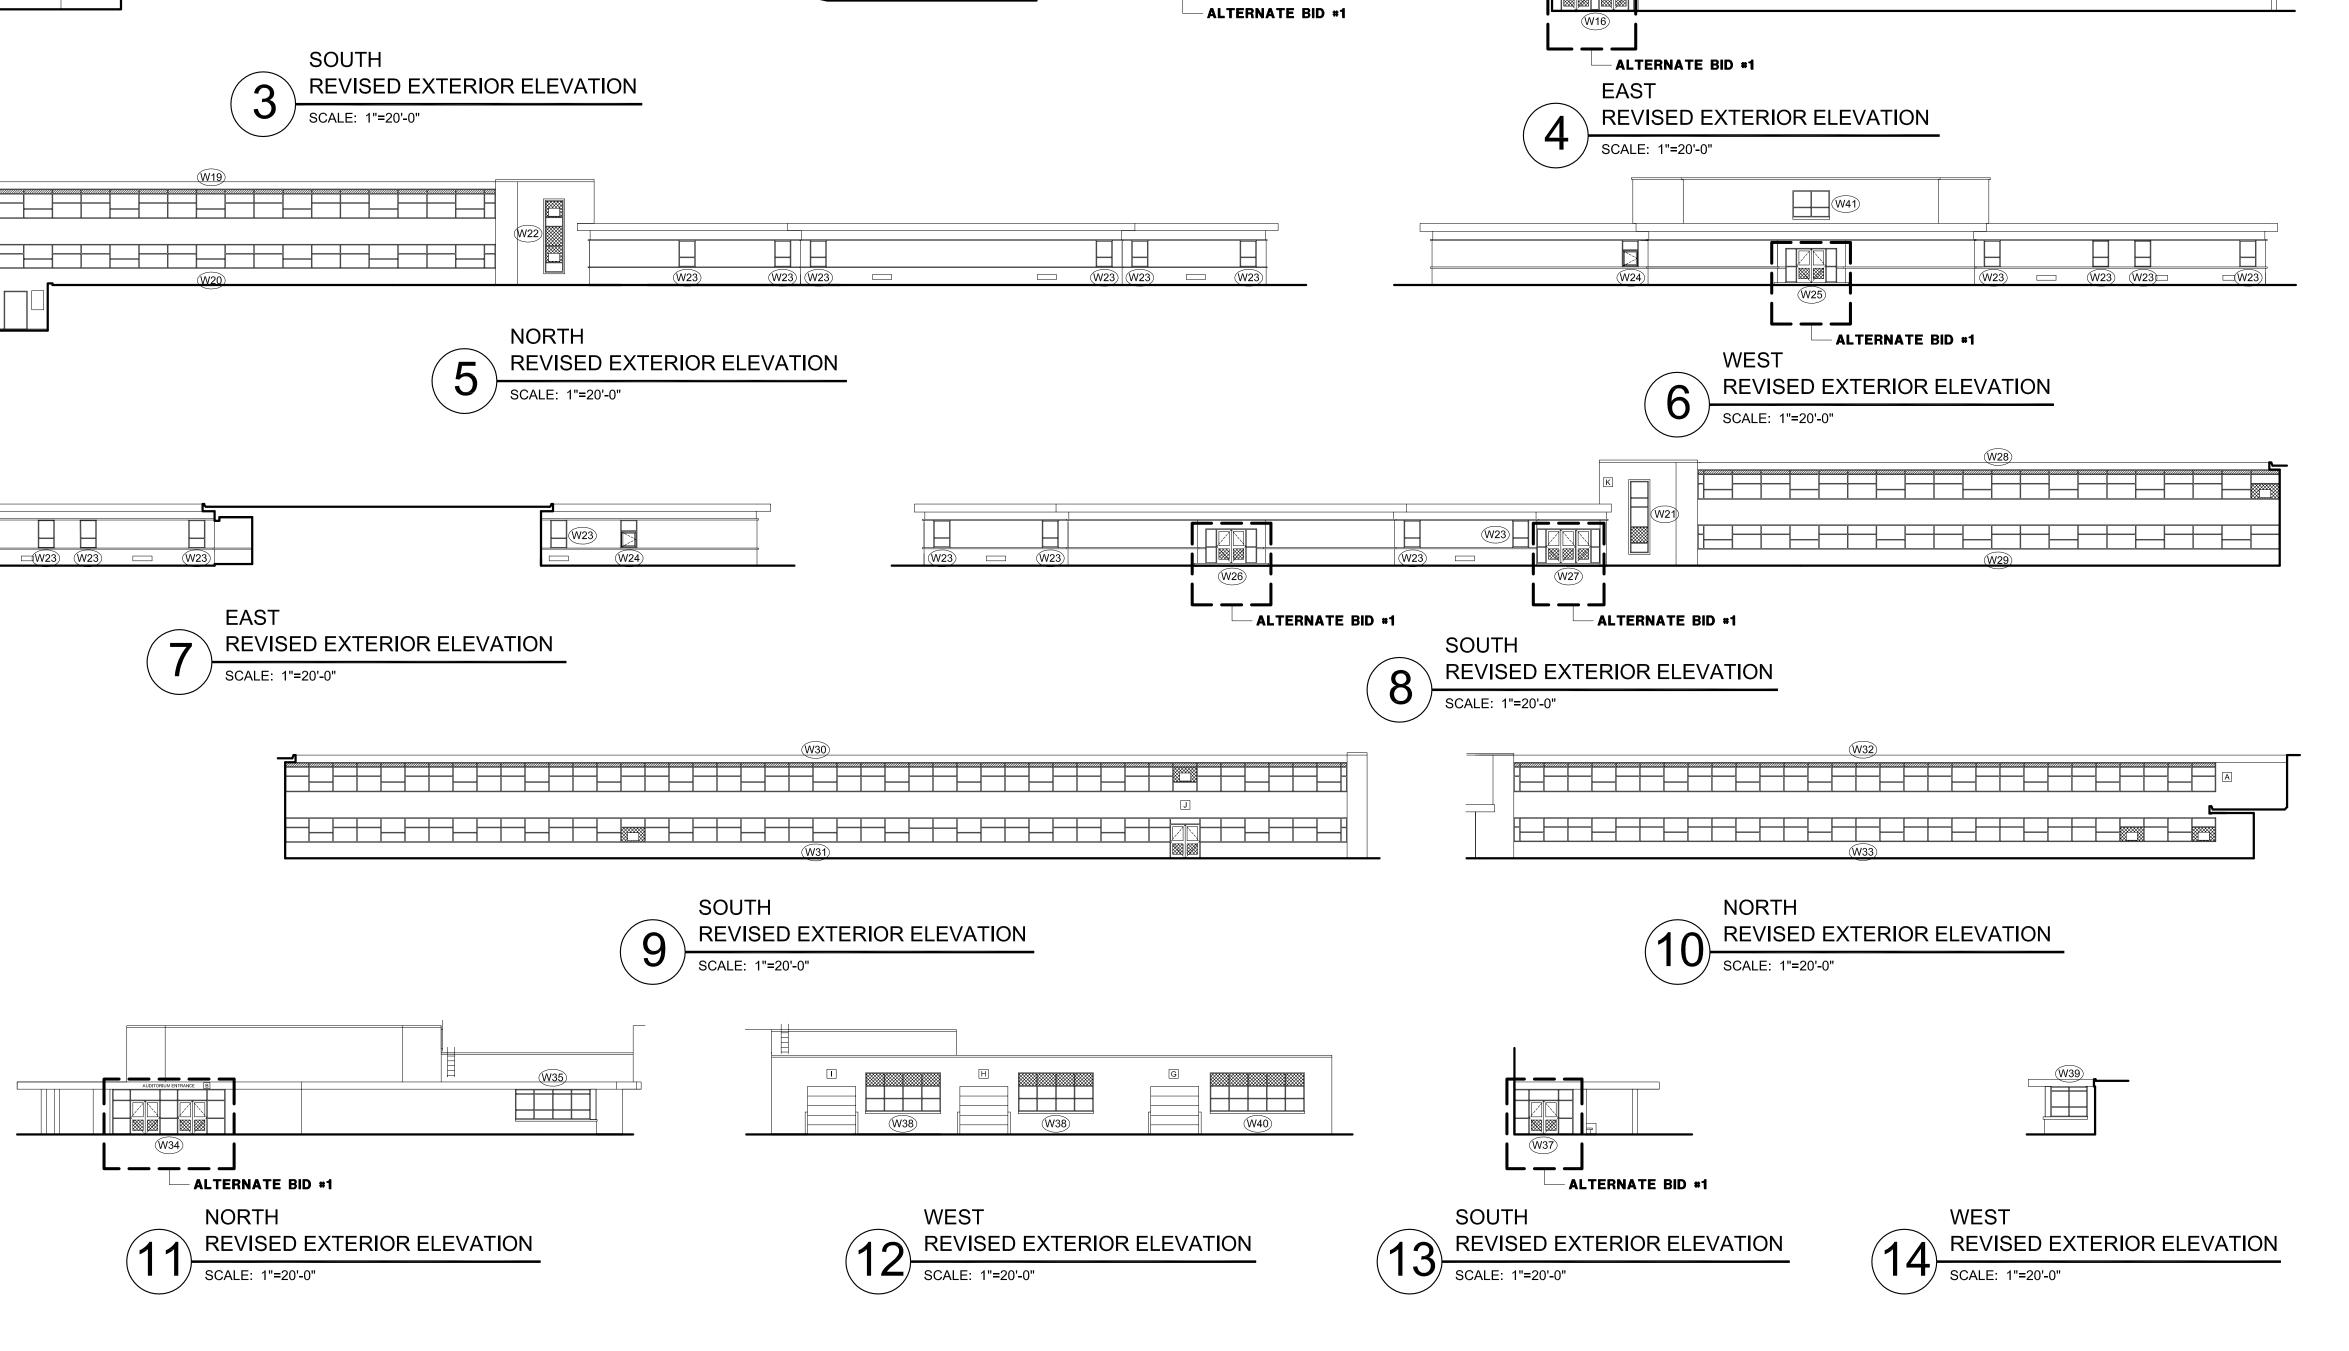

EAST

SCALE: 1"=20'-0"


(W9) (W10) (W11)

REVISED EXTERIOR ELEVATION

WEST

SCALE: 1"=20'-0"

REVISED EXTERIOR ELEVATION

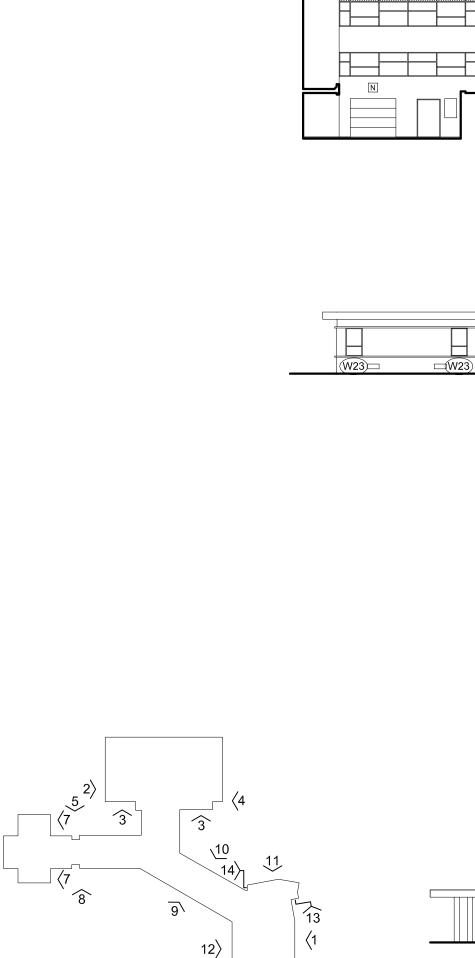

KEY PLAN

SCALE: NONE


W14) W14) W14) W14)

FRAME T

October 14, 2015

Date Oc Nate

SHEET NUMBER

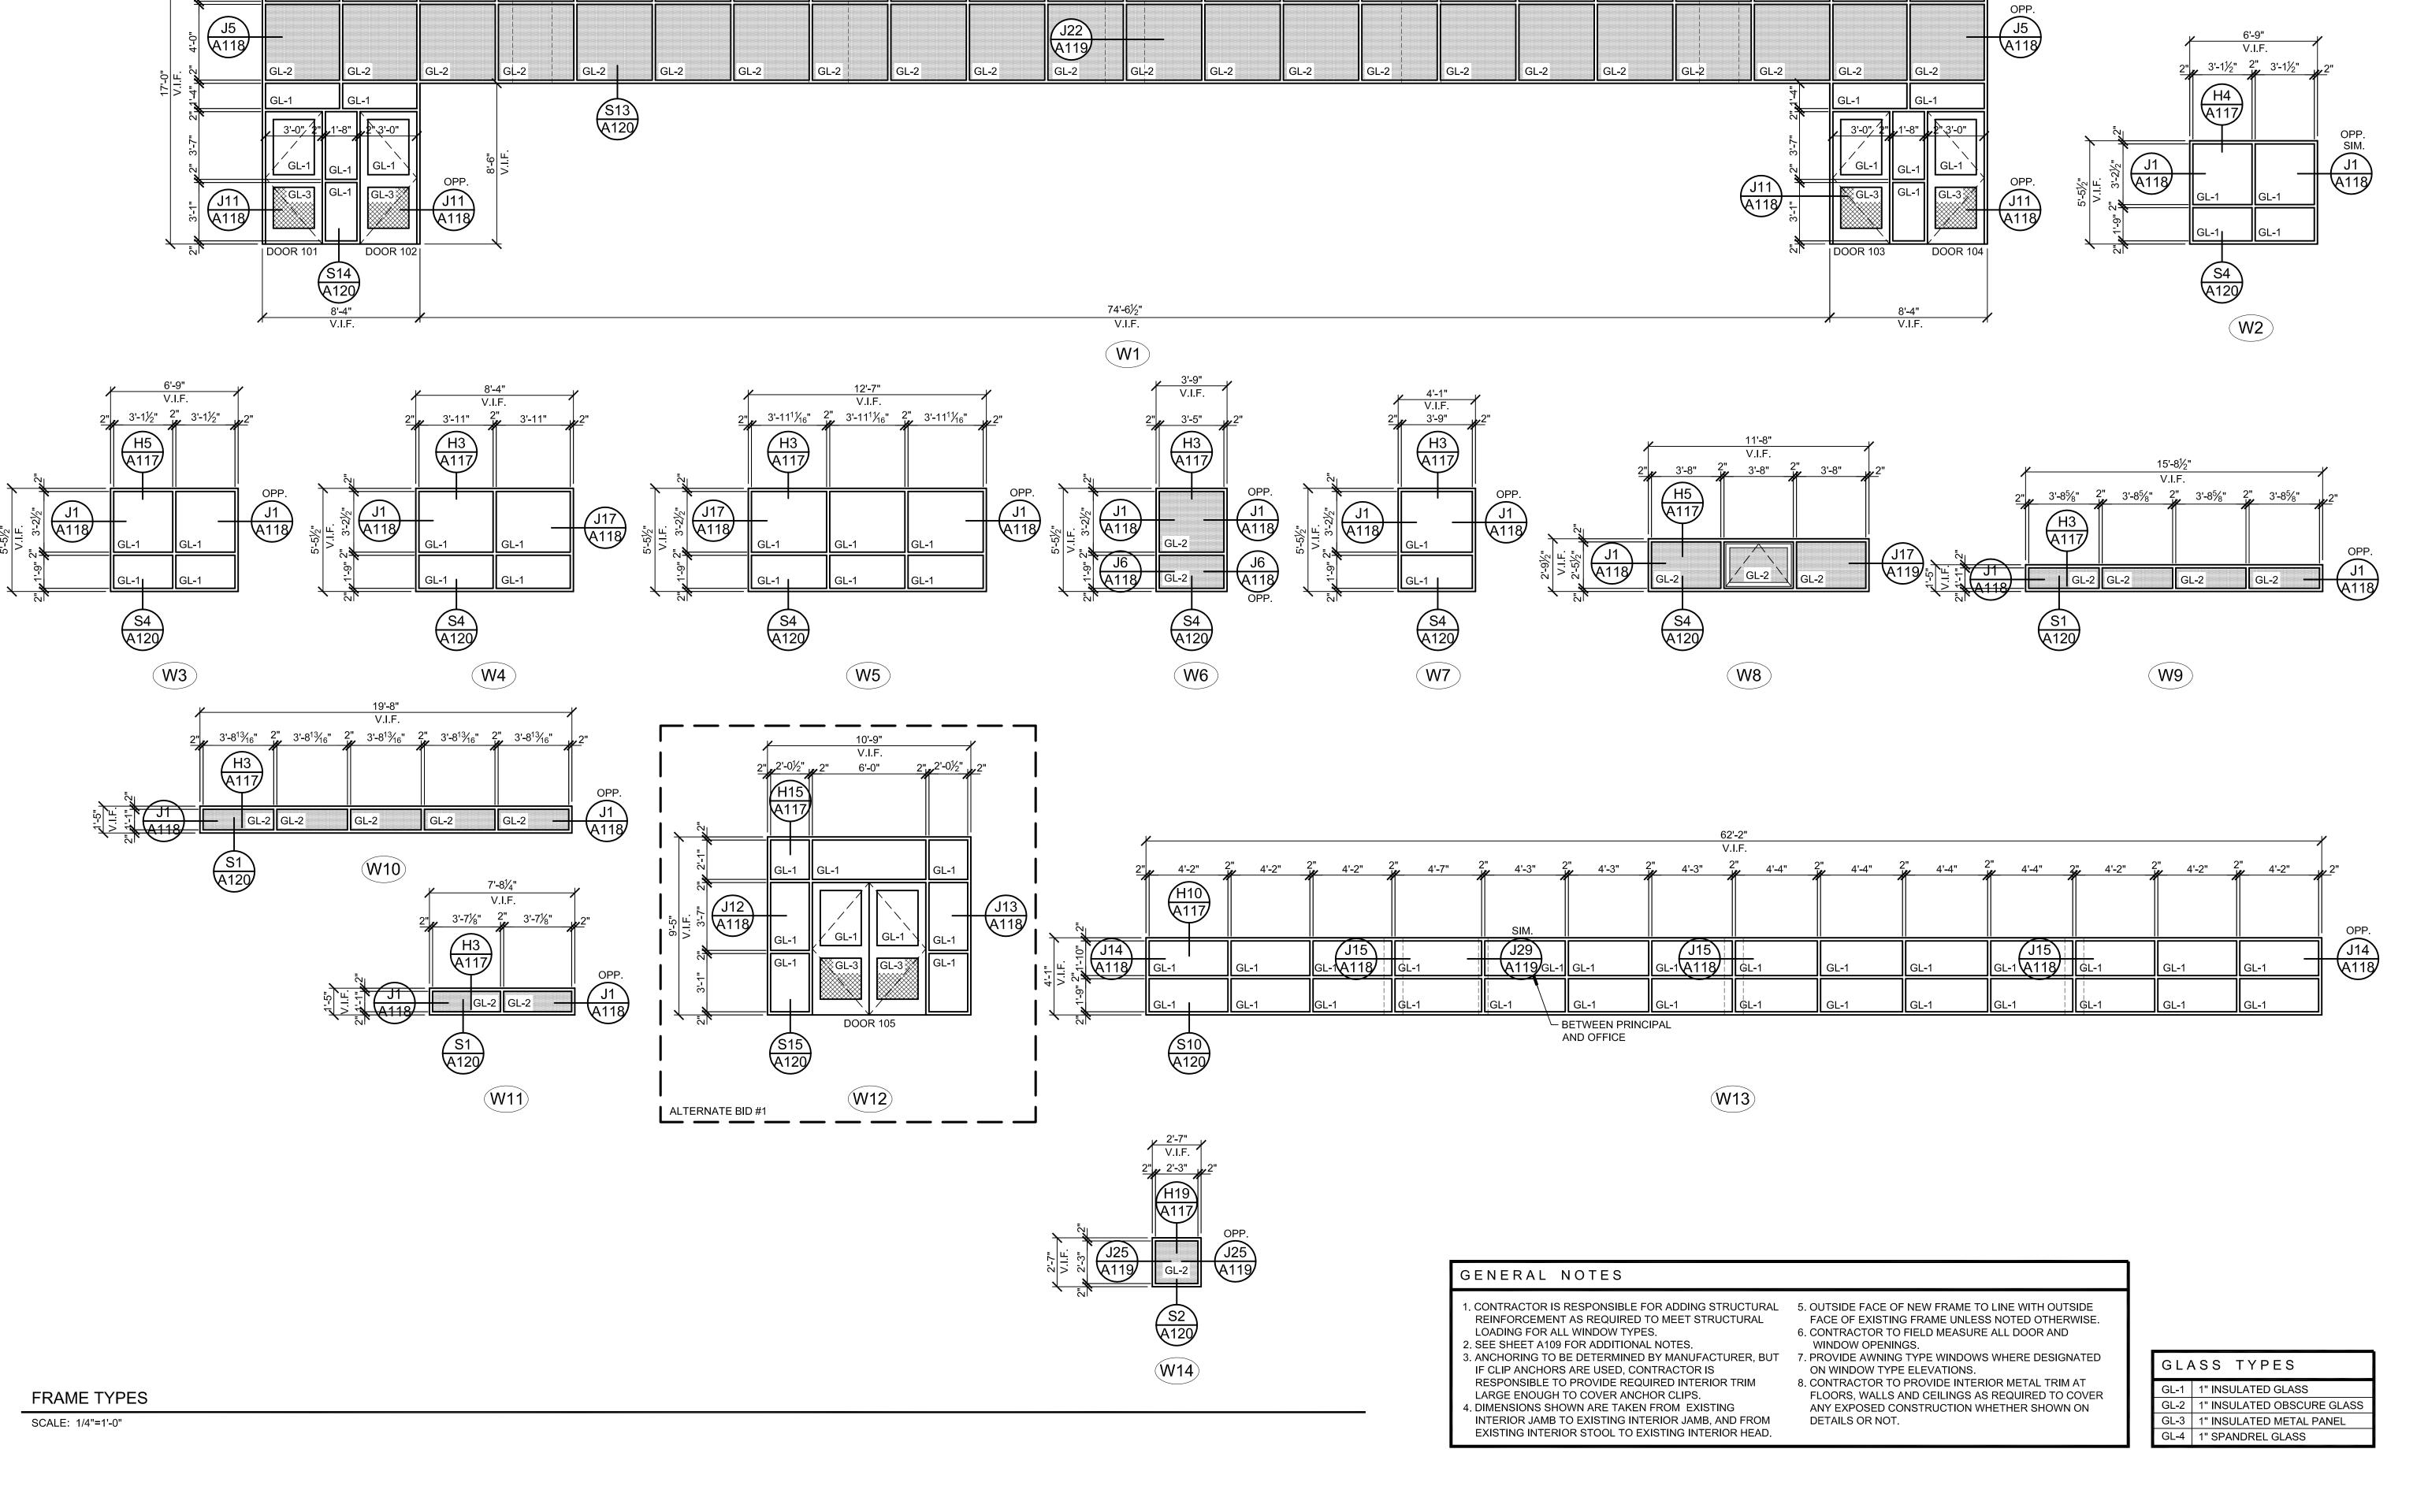

3'-11'' $2''_{\mu}$ $3'-11^{13}'_{6}$ $3''_{\mu}$ $3''_{\mu$


H14 A117




L. Johnson Associates, Inc. architects • interior designers
Charles Street; Rockford, IL 61108
815/398-1231 815/398-1280 Fax

RAME

SHEET NUMBER A112

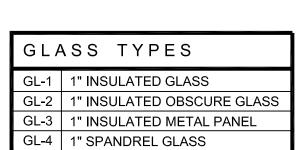

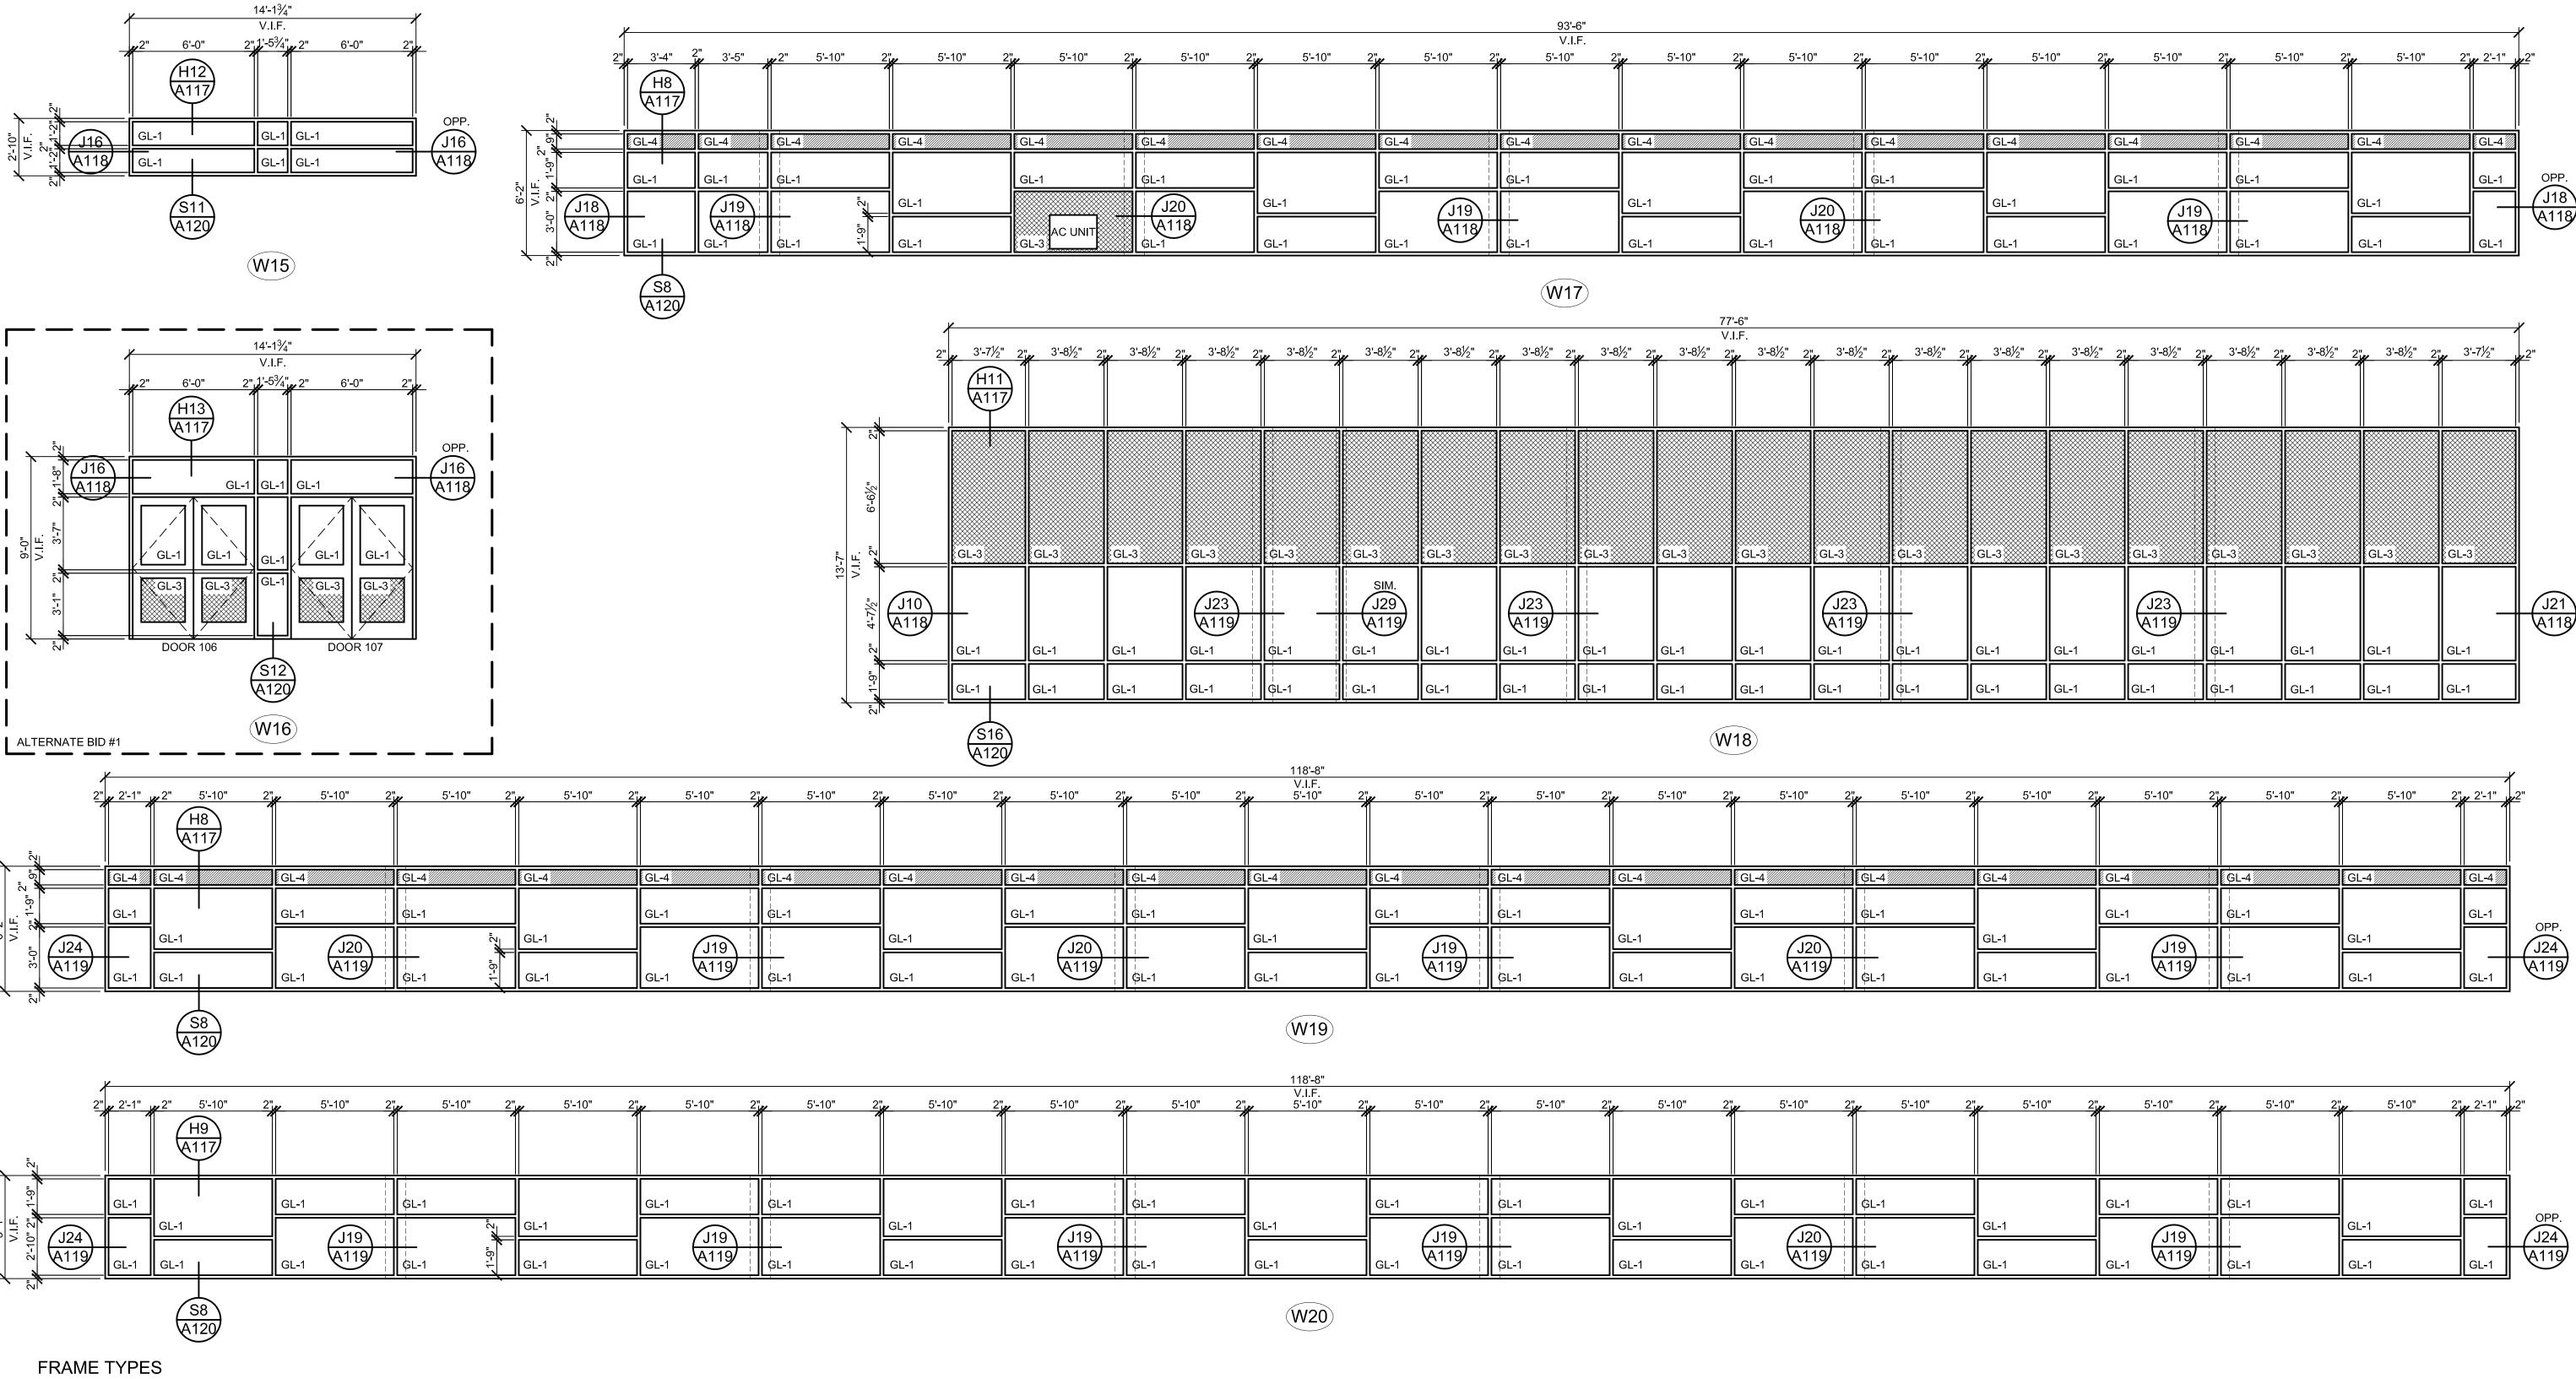

GENERAL NOTES

LOADING FOR ALL WINDOW TYPES.

2. SEE SHEET A109 FOR ADDITIONAL NOTES.

IF CLIP ANCHORS ARE USED, CONTRACTOR IS

4. DIMENSIONS SHOWN ARE TAKEN FROM EXISTING

LARGE ENOUGH TO COVER ANCHOR CLIPS.

REINFORCEMENT AS REQUIRED TO MEET STRUCTURAL

RESPONSIBLE TO PROVIDE REQUIRED INTERIOR TRIM

INTERIOR JAMB TO EXISTING INTERIOR JAMB, AND FROM

EXISTING INTERIOR STOOL TO EXISTING INTERIOR HEAD.

1. CONTRACTOR IS RESPONSIBLE FOR ADDING STRUCTURAL 5. OUTSIDE FACE OF NEW FRAME TO LINE WITH OUTSIDE

3. ANCHORING TO BE DETERMINED BY MANUFACTURER, BUT 7. PROVIDE AWNING TYPE WINDOWS WHERE DESIGNATED

FACE OF EXISTING FRAME UNLESS NOTED OTHERWISE.

6. CONTRACTOR TO FIELD MEASURE ALL DOOR AND

8. CONTRACTOR TO PROVIDE INTERIOR METAL TRIM AT

FLOORS, WALLS AND CEILINGS AS REQUIRED TO COVER

ANY EXPOSED CONSTRUCTION WHETHER SHOWN ON

WINDOW OPENINGS.

DETAILS OR NOT.

ON WINDOW TYPE ELEVATIONS.

SCALE: 1/4"=1'-0"

GLASS TYPES


GL-1 | 1" INSULATED GLASS

GL-4 1" SPANDREL GLASS

GL-2 | 1" INSULATED OBSCURE GLASS

GL-3 1" INSULATED METAL PANEL

SHEET NUMBER A113

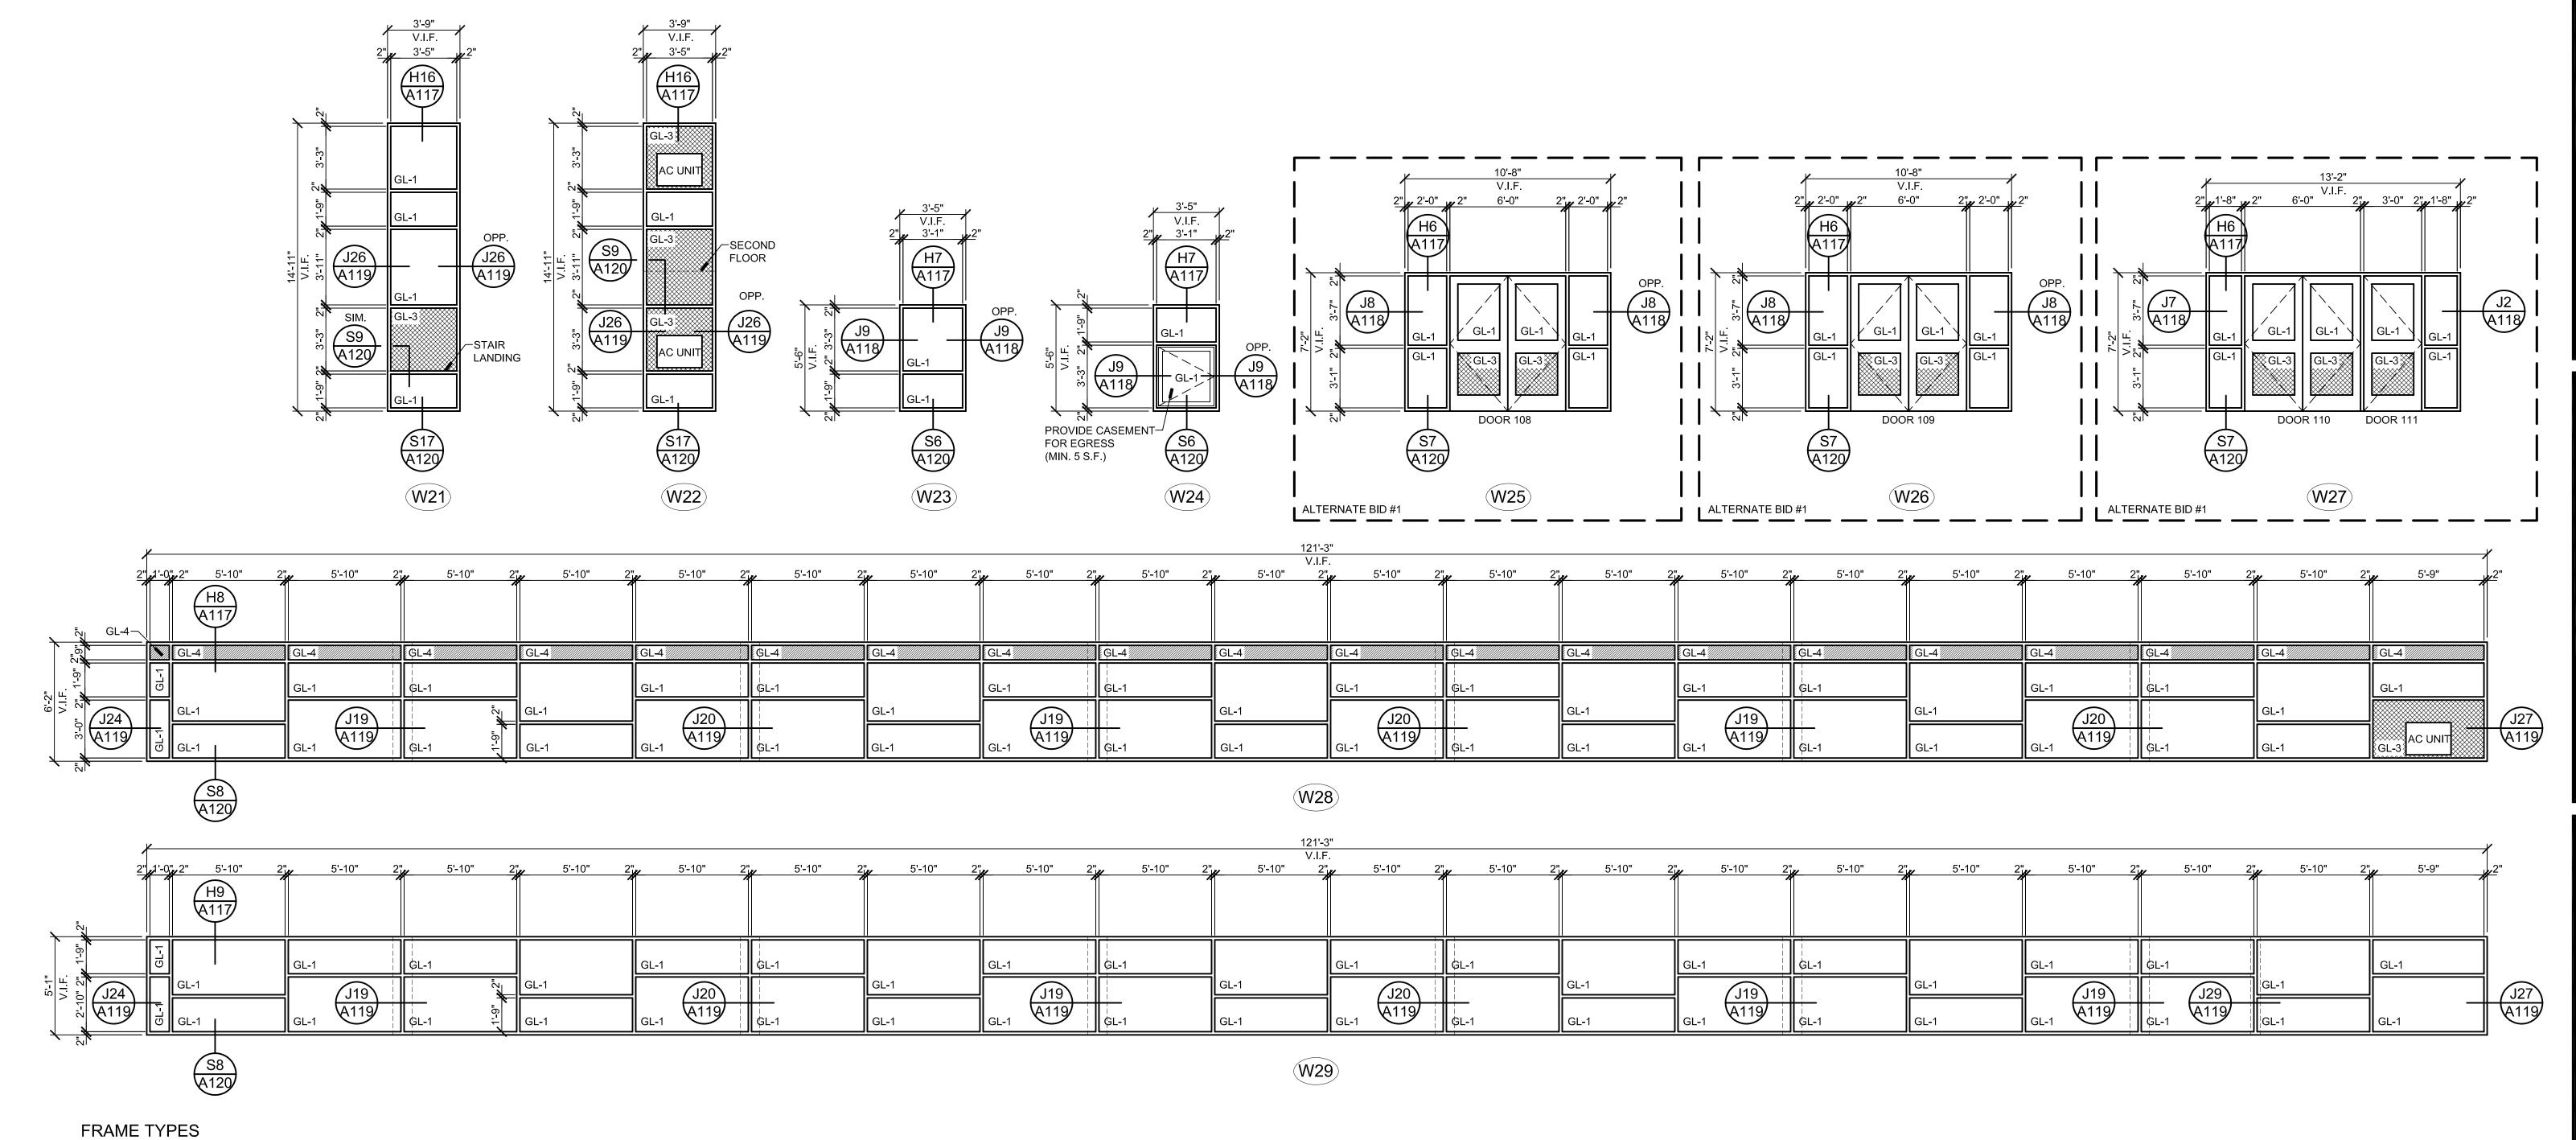

GENERAL NOTES

LOADING FOR ALL WINDOW TYPES.

2. SEE SHEET A109 FOR ADDITIONAL NOTES.

IF CLIP ANCHORS ARE USED, CONTRACTOR IS

4. DIMENSIONS SHOWN ARE TAKEN FROM EXISTING

LARGE ENOUGH TO COVER ANCHOR CLIPS.

REINFORCEMENT AS REQUIRED TO MEET STRUCTURAL

3. ANCHORING TO BE DETERMINED BY MANUFACTURER, BUT

INTERIOR JAMB TO EXISTING INTERIOR JAMB, AND FROM

EXISTING INTERIOR STOOL TO EXISTING INTERIOR HEAD.

RESPONSIBLE TO PROVIDE REQUIRED INTERIOR TRIM

1. CONTRACTOR IS RESPONSIBLE FOR ADDING STRUCTURAL 5. OUTSIDE FACE OF NEW FRAME TO LINE WITH OUTSIDE

FACE OF EXISTING FRAME UNLESS NOTED OTHERWISE.

7. PROVIDE AWNING TYPE WINDOWS WHERE DESIGNATED

FLOORS, WALLS AND CEILINGS AS REQUIRED TO COVER

ANY EXPOSED CONSTRUCTION WHETHER SHOWN ON

8. CONTRACTOR TO PROVIDE INTERIOR METAL TRIM AT

6. CONTRACTOR TO FIELD MEASURE ALL DOOR AND

WINDOW OPENINGS.

DETAILS OR NOT.

ON WINDOW TYPE ELEVATIONS.

SCALE: 1/4"=1'-0"


GL-2 | 1" INSULATED OBSCURE GLASS GL-3 1" INSULATED METAL PANEL

GLASS TYPES

GL-1 | 1" INSULATED GLASS

GL-4 1" SPANDREL GLASS

SHEET NUMBER

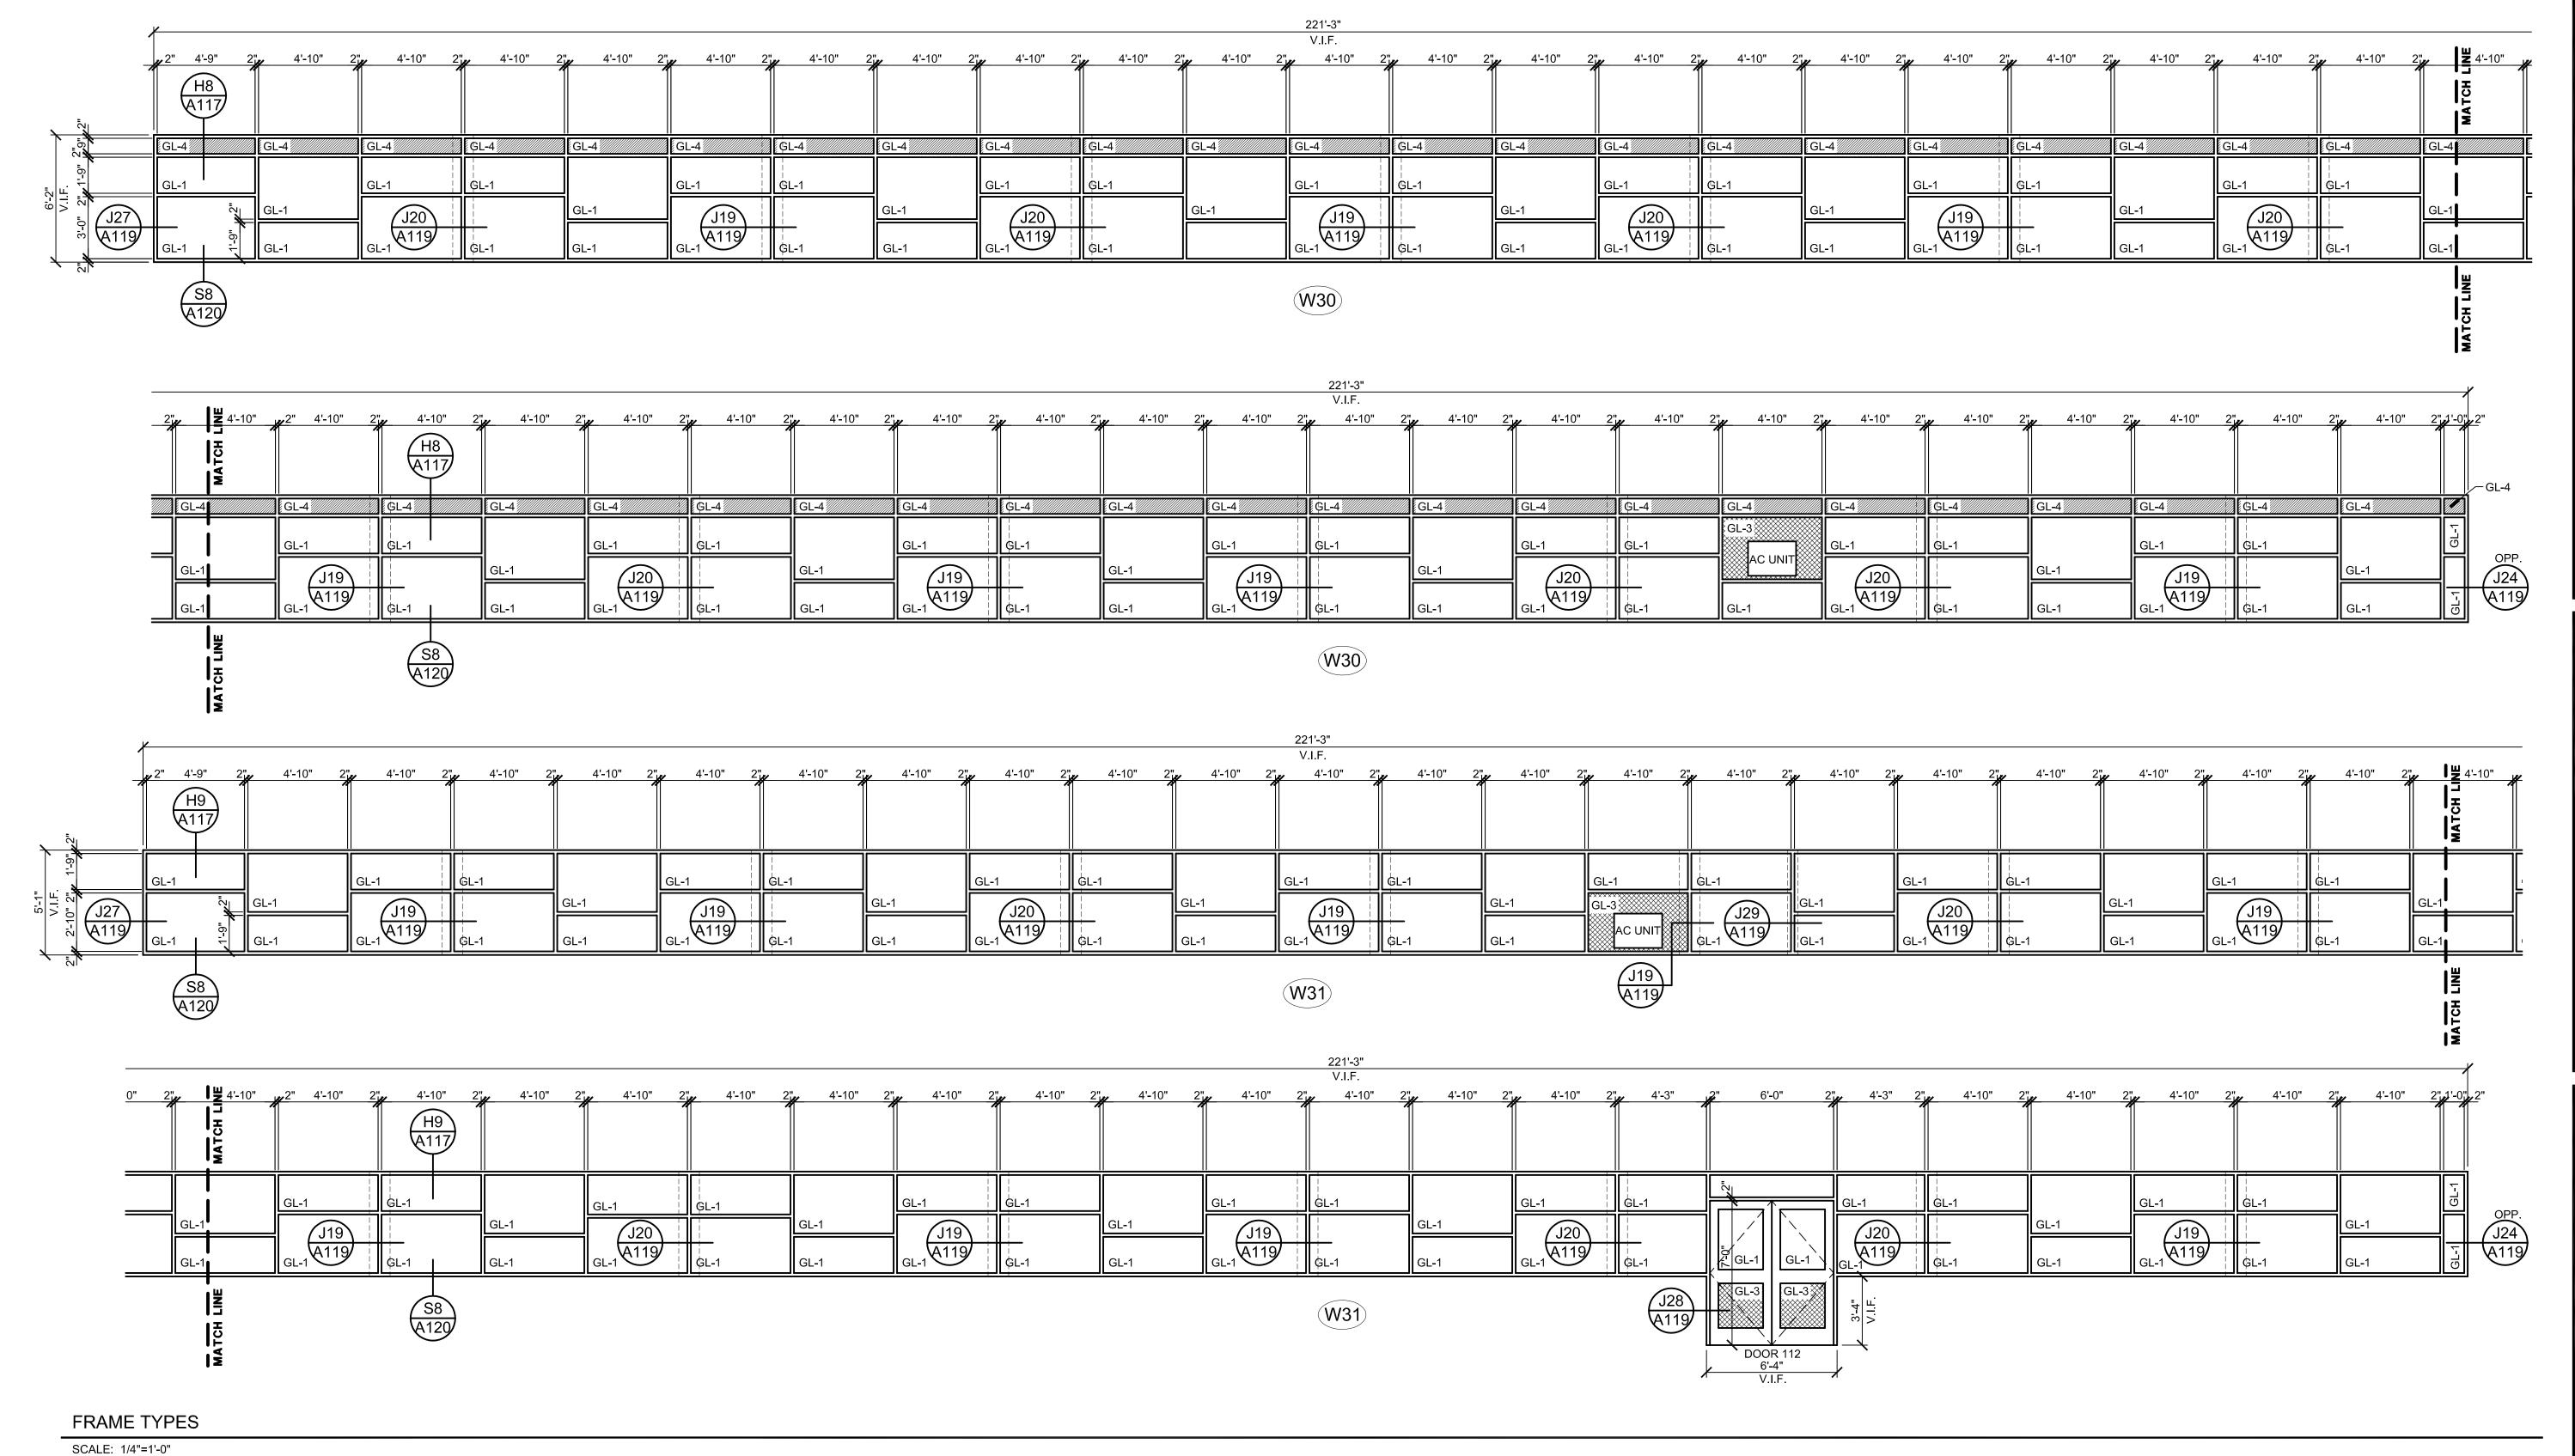

GENERAL NOTES

LOADING FOR ALL WINDOW TYPES.

2. SEE SHEET A109 FOR ADDITIONAL NOTES.

IF CLIP ANCHORS ARE USED, CONTRACTOR IS

4. DIMENSIONS SHOWN ARE TAKEN FROM EXISTING

LARGE ENOUGH TO COVER ANCHOR CLIPS.

REINFORCEMENT AS REQUIRED TO MEET STRUCTURAL

3. ANCHORING TO BE DETERMINED BY MANUFACTURER, BUT

RESPONSIBLE TO PROVIDE REQUIRED INTERIOR TRIM

INTERIOR JAMB TO EXISTING INTERIOR JAMB, AND FROM

EXISTING INTERIOR STOOL TO EXISTING INTERIOR HEAD.

1. CONTRACTOR IS RESPONSIBLE FOR ADDING STRUCTURAL 5. OUTSIDE FACE OF NEW FRAME TO LINE WITH OUTSIDE

FACE OF EXISTING FRAME UNLESS NOTED OTHERWISE.

7. PROVIDE AWNING TYPE WINDOWS WHERE DESIGNATED

FLOORS, WALLS AND CEILINGS AS REQUIRED TO COVER

ANY EXPOSED CONSTRUCTION WHETHER SHOWN ON

8. CONTRACTOR TO PROVIDE INTERIOR METAL TRIM AT

6. CONTRACTOR TO FIELD MEASURE ALL DOOR AND

WINDOW OPENINGS.

DETAILS OR NOT.

ON WINDOW TYPE ELEVATIONS.

GL-2 | 1" INSULATED OBSCURE GLASS

GL-4 1" SPANDREL GLASS

GENERAL NOTES

1. CONTRACTOR IS RESPONSIBLE FOR ADDING STRUCTURAL 5. OUTSIDE FACE OF NEW FRAME TO LINE WITH OUTSIDE REINFORCEMENT AS REQUIRED TO MEET STRUCTURAL

LOADING FOR ALL WINDOW TYPES. 2. SEE SHEET A109 FOR ADDITIONAL NOTES.

IF CLIP ANCHORS ARE USED, CONTRACTOR IS RESPONSIBLE TO PROVIDE REQUIRED INTERIOR TRIM LARGE ENOUGH TO COVER ANCHOR CLIPS. 4. DIMENSIONS SHOWN ARE TAKEN FROM EXISTING

3. ANCHORING TO BE DETERMINED BY MANUFACTURER, BUT

(W33)

146'-3" V.I.F.

INTERIOR JAMB TO EXISTING INTERIOR JAMB, AND FROM EXISTING INTERIOR STOOL TO EXISTING INTERIOR HEAD.

FACE OF EXISTING FRAME UNLESS NOTED OTHERWISE.

6. CONTRACTOR TO FIELD MEASURE ALL DOOR AND WINDOW OPENINGS.

7. PROVIDE AWNING TYPE WINDOWS WHERE DESIGNATED ON WINDOW TYPE ELEVATIONS. 8. CONTRACTOR TO PROVIDE INTERIOR METAL TRIM AT FLOORS, WALLS AND CEILINGS AS REQUIRED TO COVER ANY EXPOSED CONSTRUCTION WHETHER SHOWN ON

DETAILS OR NOT.

GLASS TYPES GL-1 | 1" INSULATED GLASS GL-3 1" INSULATED METAL PANEL

J20 A119

	GL-1		GL-1 GL-1	J19 A119	GL-1	GL-1	J20 A119	#+	GL-1 GL-1	J19 A119	GL-1	GL-1	J20 A119	GL-1
		MATCH LINE			S8 A120					W32				
1'-C	H9 A117	" 2	2", 4'-10" :	2", 4'-10"	2", 4'-10"	2", 4'-10"	2", 4'-10"	2", 4'-10"	146'-3" V.I.F. 2", 4'-10"	2", 4'-10"	2", 4'-10"	2", 4'-10"	2", 4'-10"	2", 4'-10"
			GL-1 J19 A119	GL-1 "Z" "6-1		GL-1 J19 A119	GL-1	GL-1	GL-1 J20 A119	GL-1	GL-1	GL-1 J19 A119	GL-1	GL-1
<u>o</u>	S8 A120		GL-1	GL-1 -	GL-1	GL-1		GL-1	W33	¦	GL-1	GL-1 (19	GL-1	GL-1
0"	y 4'-10"	1 w	2" 4'-10" 2'	41.40	011 41 4011	01 41 401 4				146'-3" V.I.F.				01 41 401
2"	4:-10"	MATCH LIN	2" 4'-10" 2'	4'-10"	2" 4'-10" H9 A117	2", 4'-10" 2	2", 4'-10" 2	2", 4'-10" 2	2", 4'-10" 2	2", 4'-10" 2	2", 4'-10" :	2", 4'-10"	2", 4'-10"	2", 4'-10"
	GL-1	 	GL-1	GL-1	GL-1	GL-1	GL-1	GL-1	GL-1	GL-1	GL-1 J29	GL-1	GL-1	GL-1

J19 A119

H8 A117

A117

FRAME TYPES


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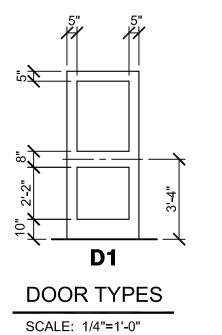
A116

GLASS TYPES GL-1 | 1" INSULATED GLASS GL-2 | 1" INSULATED OBSCURE GLASS


GL-3 1" INSULATED METAL PANEL

GL-4 1" SPANDREL GLASS



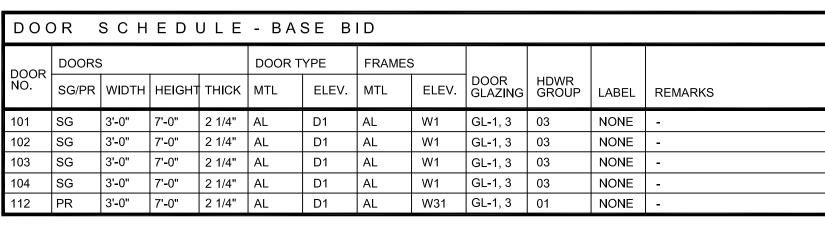

DOC	DOOR SCHEDULE - ALTERNATE BID #1											
DOOR NO.	DOORS	3			DOOR TYPE		FRAMES					
	SG/PR	WIDTH	HEIGHT	THICK	MTL	ELEV.	MTL	ELEV.	DOOR GLAZING	HDWR GROUP	LABEL	REMARKS
105	PR	3'-0"	7'-0"	2 1/4"	AL	D1	AL	W12	GL-1, 3	01	NONE	-
106	PR	3'-0"	7'-0"	2 1/4"	AL	D1	AL	W16	GL-1, 3	01	NONE	-
107	PR	3'-0"	7'-0"	2 1/4"	AL	D1	AL	W16	GL-1, 3	01	NONE	-
108	PR	3'-0"	7'-0"	2 1/4"	AL	D1	AL	W25	GL-1, 3	02	NONE	-
109	PR	3'-0"	7'-0"	2 1/4"	AL	D1	AL	W26	GL-1, 3	01	NONE	-
110	PR	3'-0"	7'-0"	2 1/4"	AL	D1	AL	W27	GL-1, 3	02	NONE	-
111	SG	3'-0"	7'-0"	2 1/4"	AL	D1	AL	W27	GL-1, 3	03	NONE	-
113	PR	3'-0"	7'-0"	2 1/4"	AL	D1	AL	W34	GL-1, 3	02	NONE	-
114	PR	3'-0"	7'-0"	2 1/4"	AL	D1	AL	W34	GL-1, 3	01	NONE	-
115	PR	3'-0"	7'-0"	2 1/4"	AL	D1	AL	W37	GL-1, 3	01	NONE	-

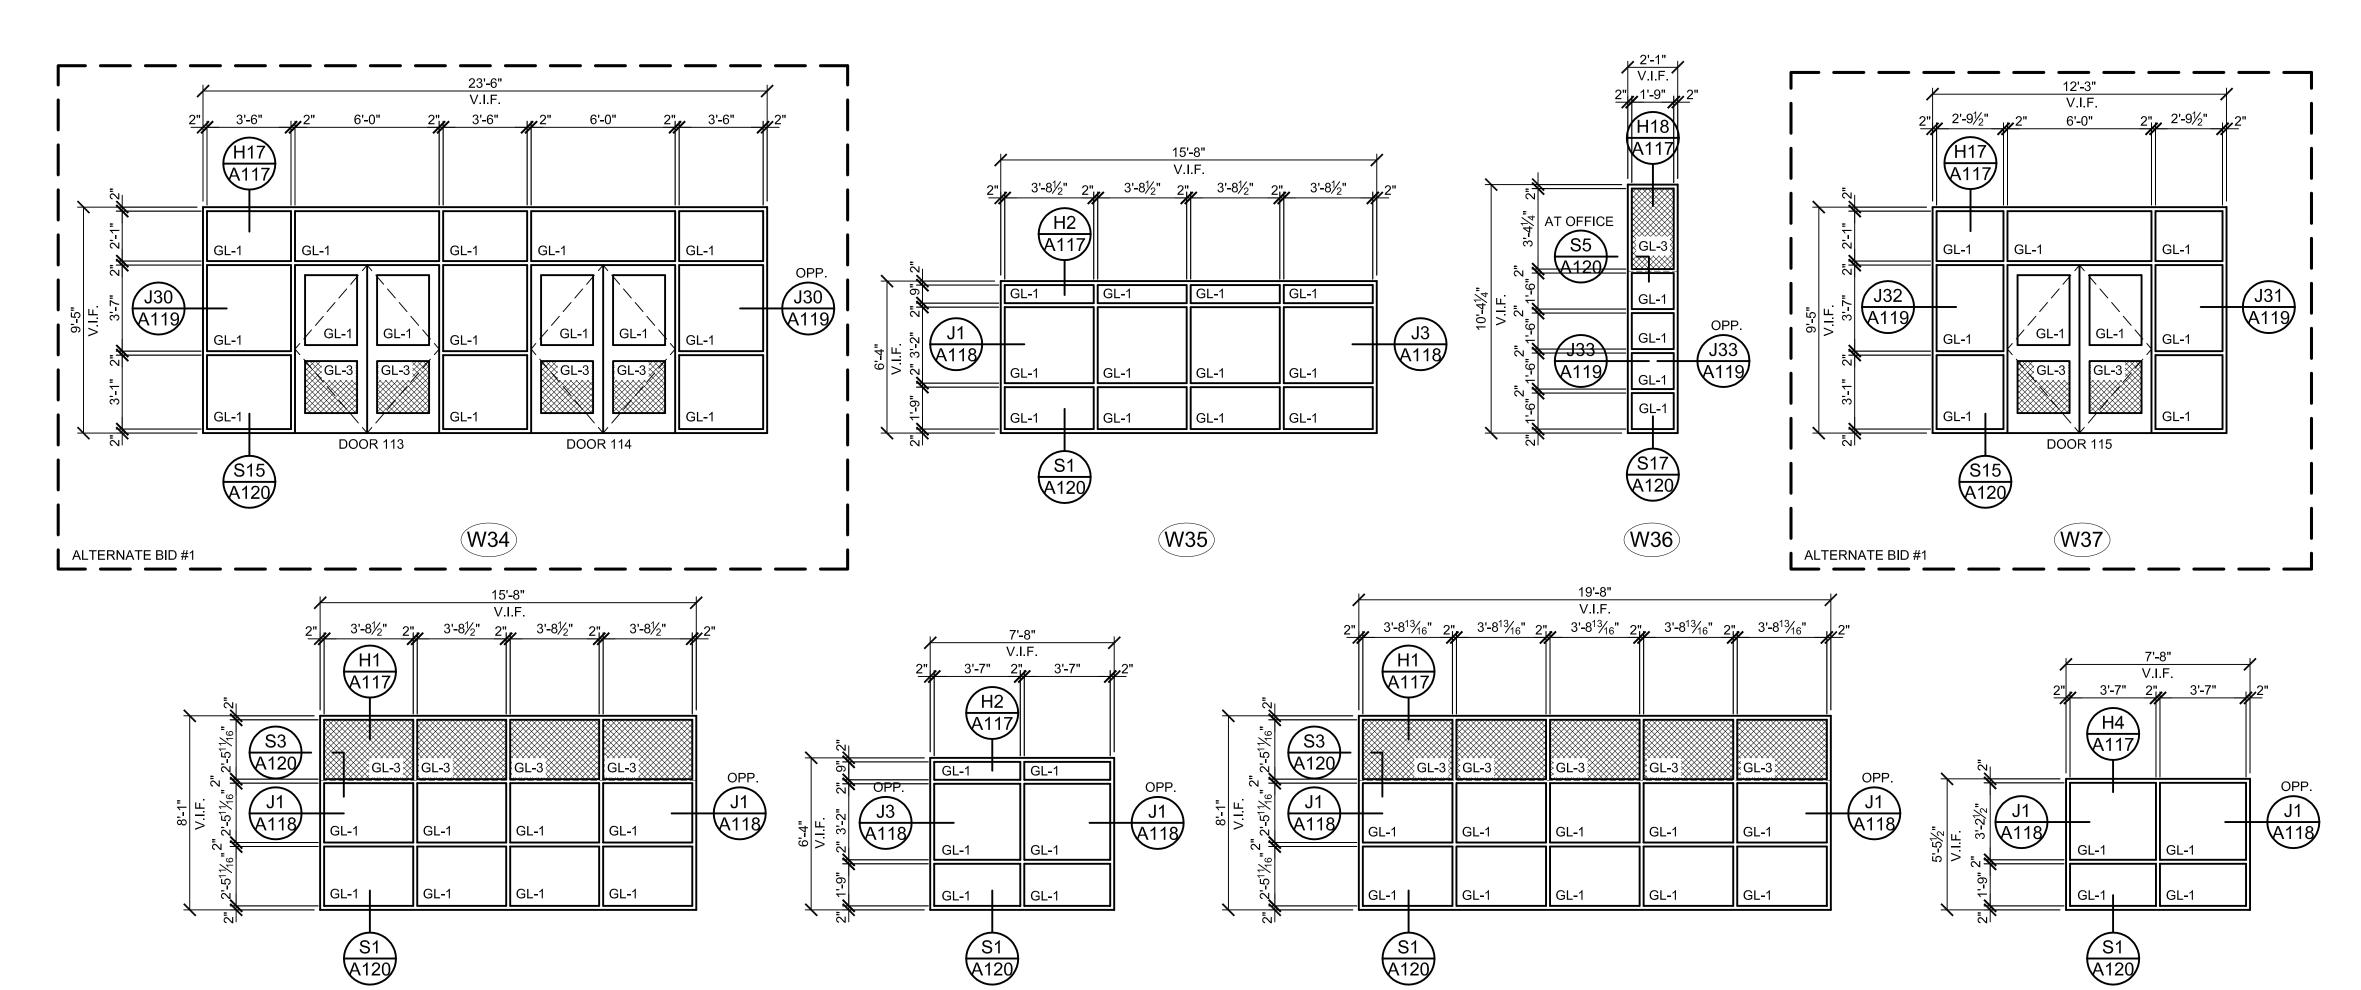

FRAME TYPES

MOCK-UP WINDOW

SCALE: 1/4"=1'-0"

GENERAL NOTES

- 1. CONTRACTOR IS RESPONSIBLE FOR ADDING STRUCTURAL 5. OUTSIDE FACE OF NEW FRAME TO LINE WITH OUTSIDE REINFORCEMENT AS REQUIRED TO MEET STRUCTURAL LOADING FOR ALL WINDOW TYPES.
- 2. SEE SHEET A109 FOR ADDITIONAL NOTES. 3. ANCHORING TO BE DETERMINED BY MANUFACTURER, BUT
- IF CLIP ANCHORS ARE USED, CONTRACTOR IS RESPONSIBLE TO PROVIDE REQUIRED INTERIOR TRIM LARGE ENOUGH TO COVER ANCHOR CLIPS.
- 4. DIMENSIONS SHOWN ARE TAKEN FROM EXISTING INTERIOR JAMB TO EXISTING INTERIOR JAMB, AND FROM EXISTING INTERIOR STOOL TO EXISTING INTERIOR HEAD.
- FACE OF EXISTING FRAME UNLESS NOTED OTHERWISE.
- 6. CONTRACTOR TO FIELD MEASURE ALL DOOR AND WINDOW OPENINGS. 7. PROVIDE AWNING TYPE WINDOWS WHERE DESIGNATED

(W40)

ON WINDOW TYPE ELEVATIONS. 8. CONTRACTOR TO PROVIDE INTERIOR METAL TRIM AT FLOORS, WALLS AND CEILINGS AS REQUIRED TO COVER ANY EXPOSED CONSTRUCTION WHETHER SHOWN ON DETAILS OR NOT.












EXISTING INTERIOR STOOL TO EXISTING INTERIOR HEAD.

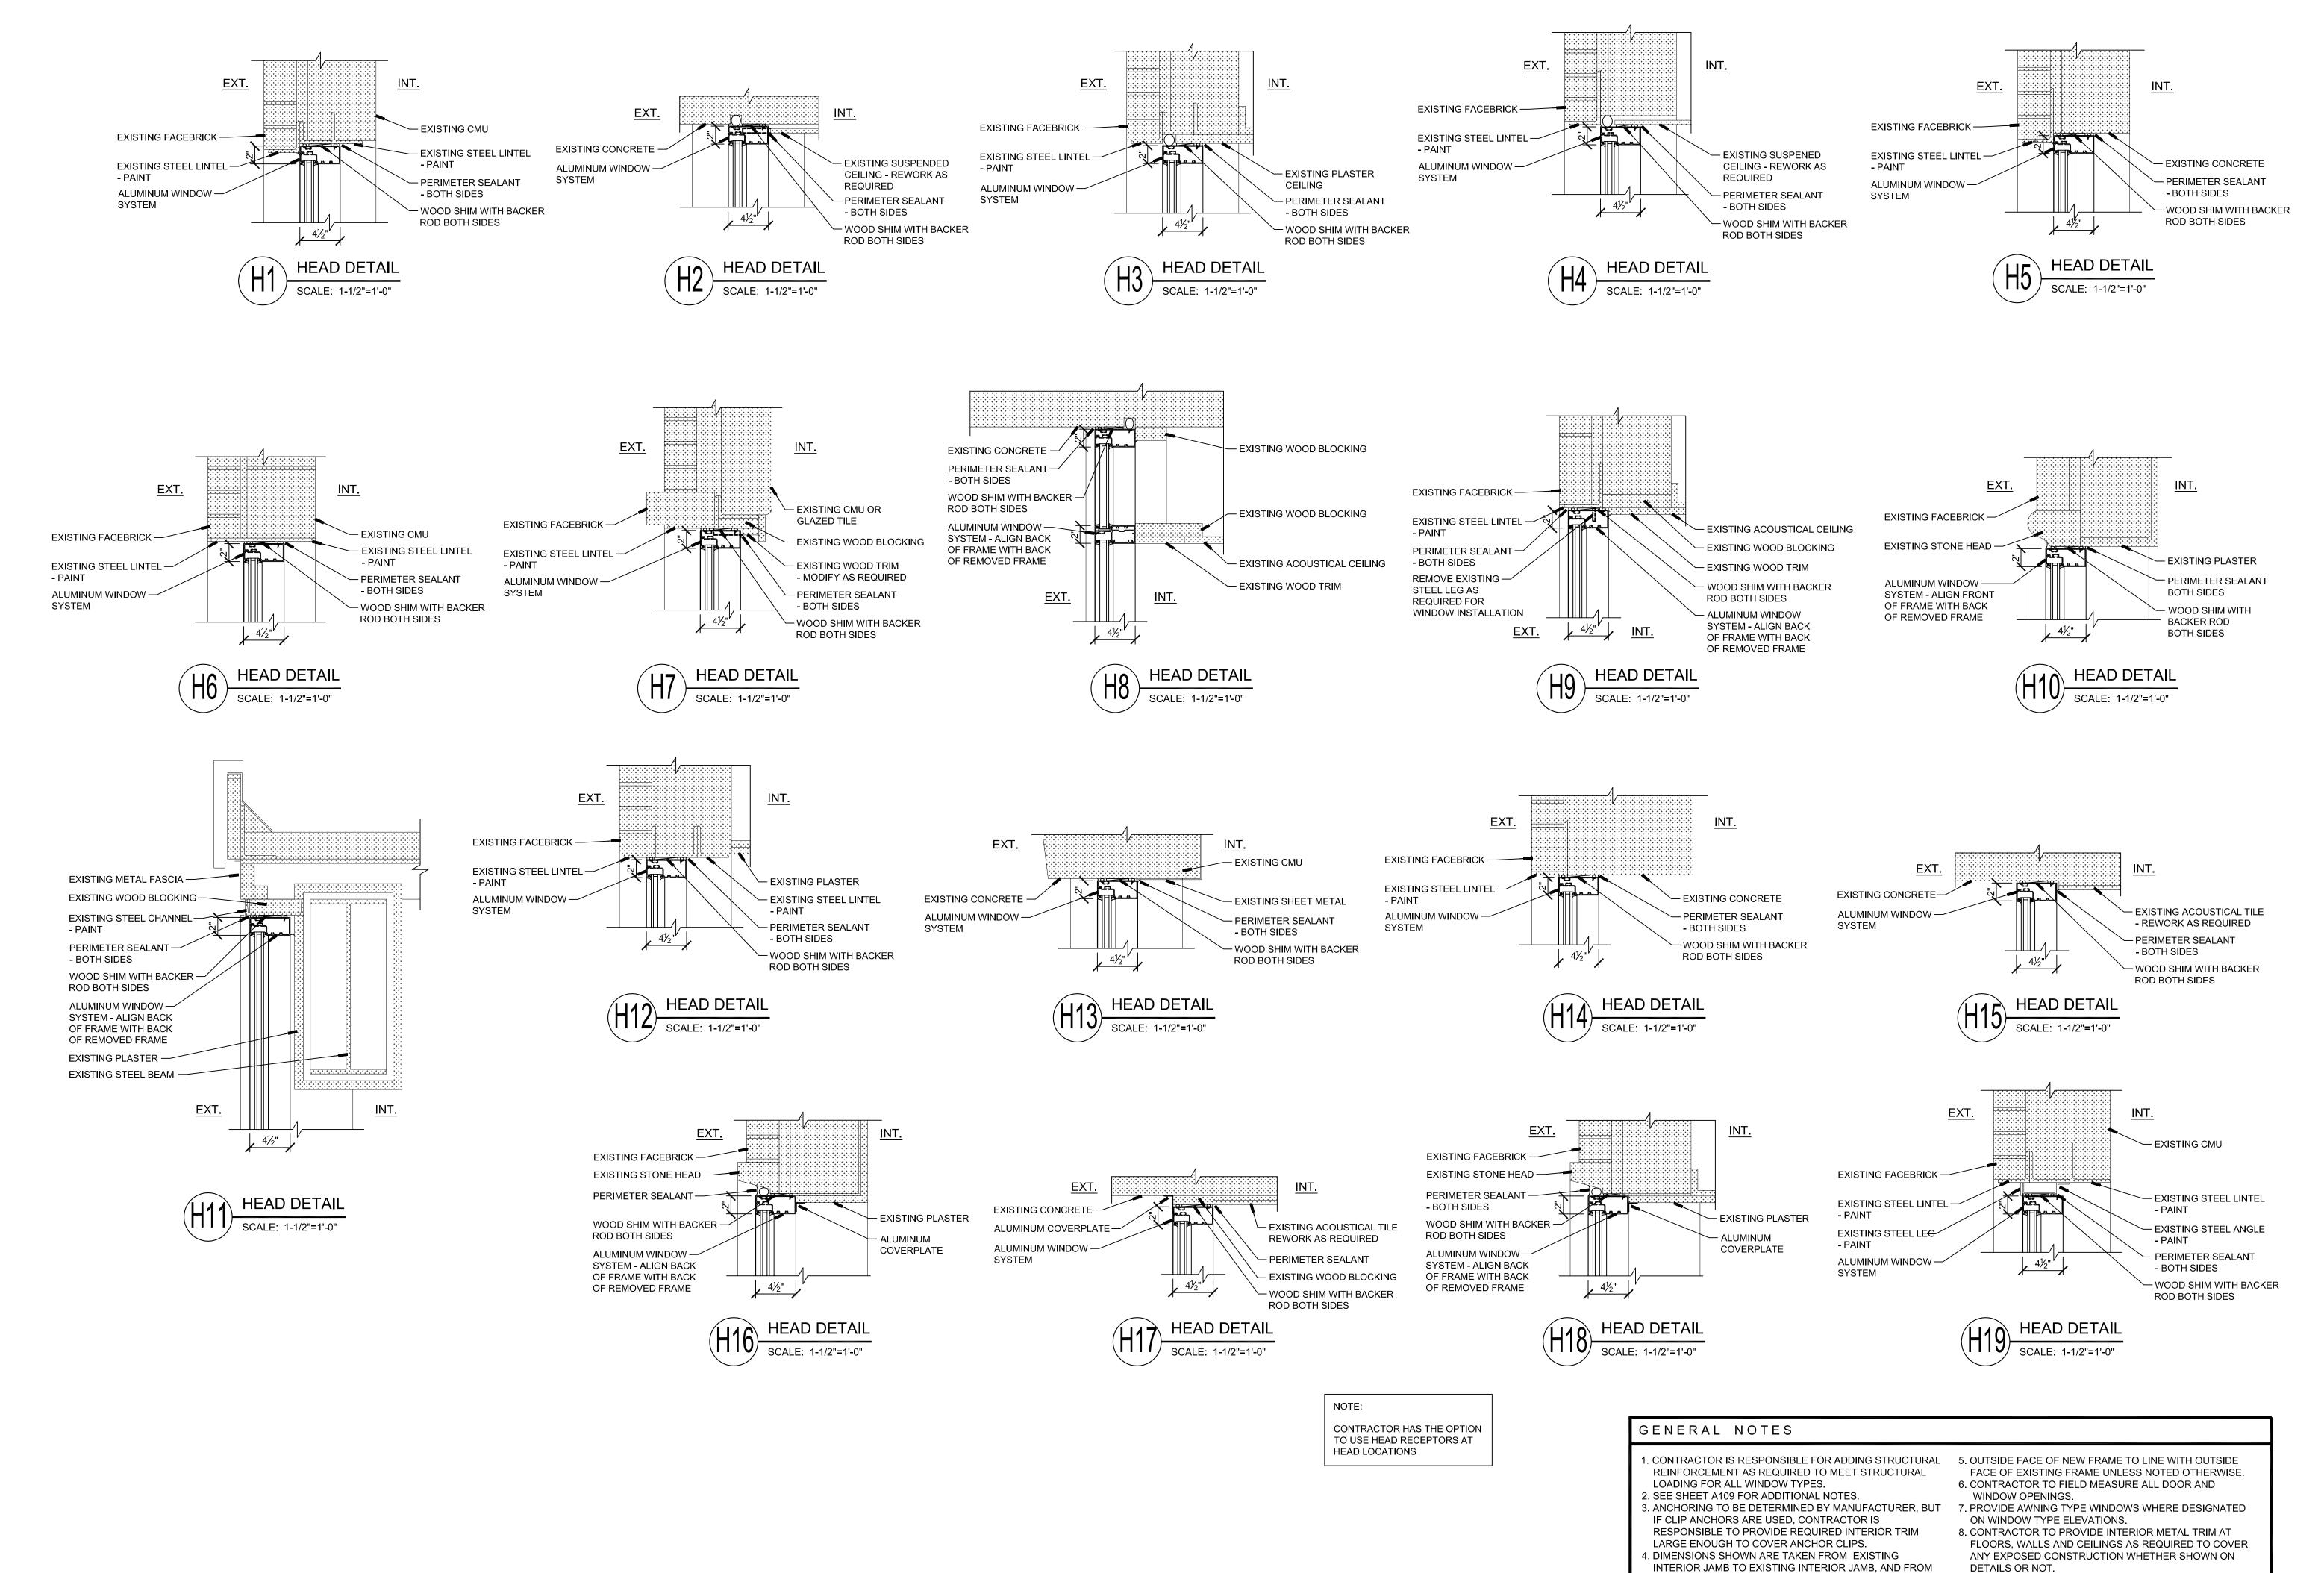











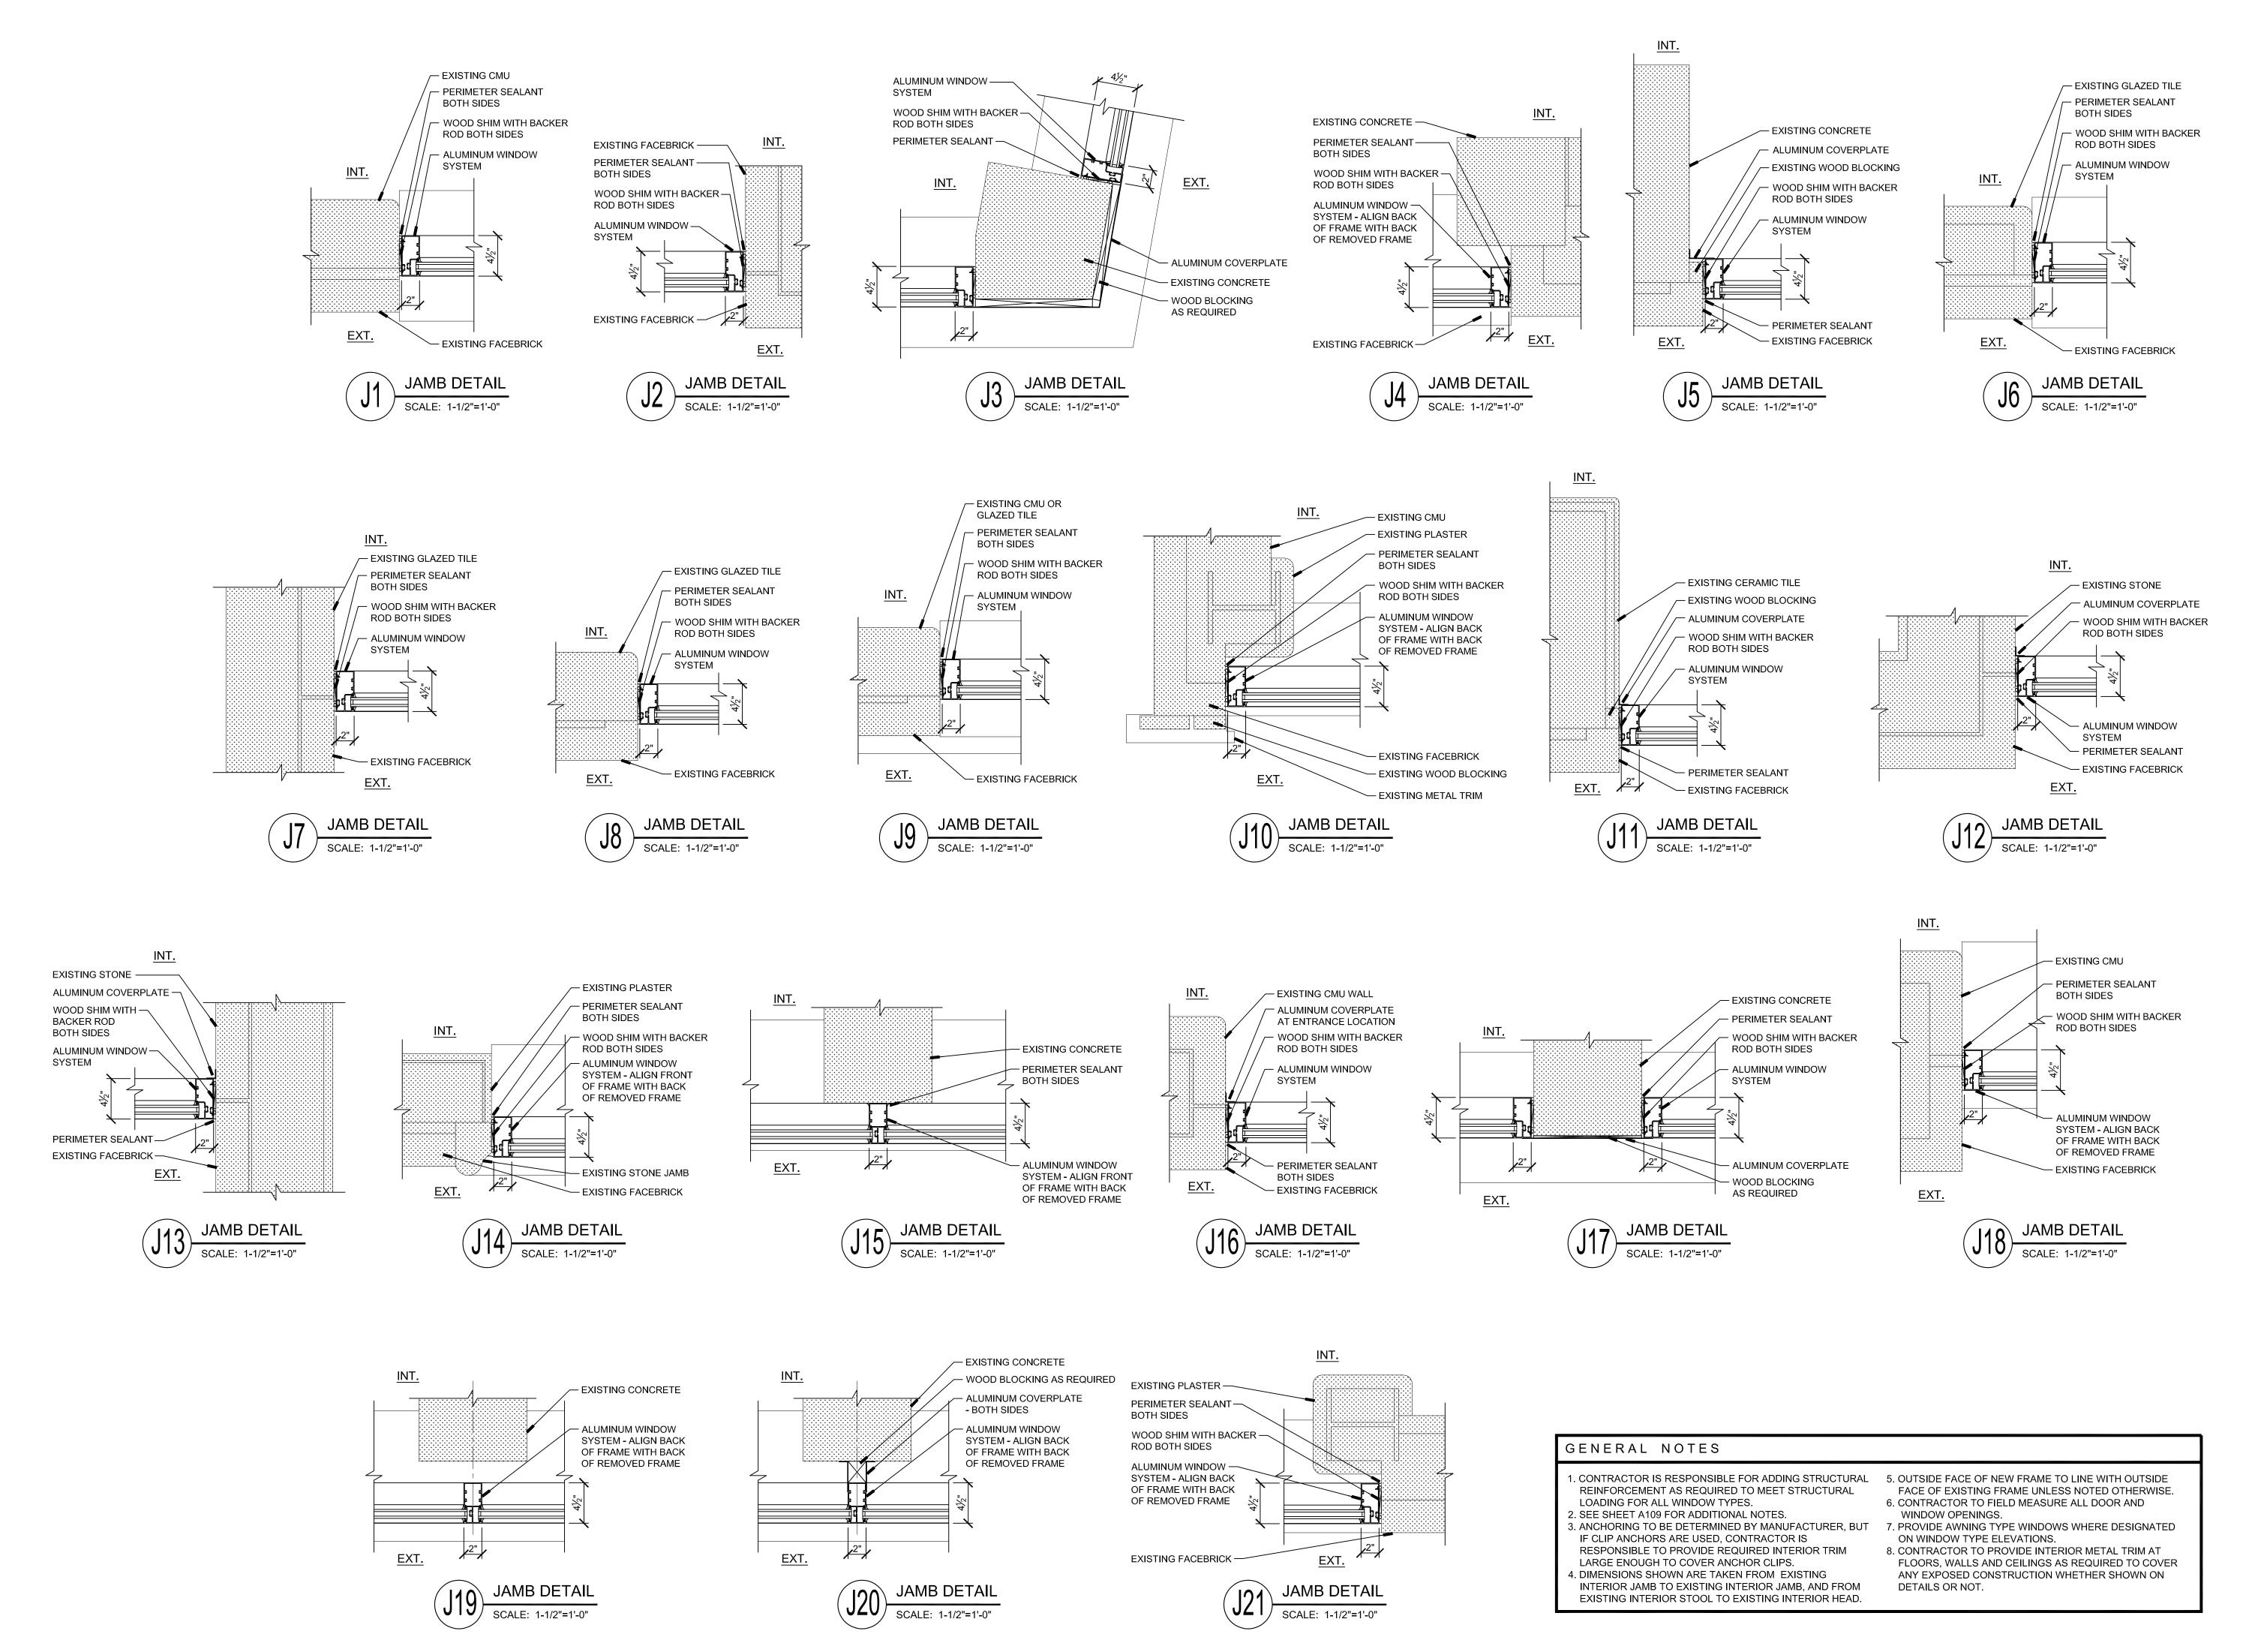

A119

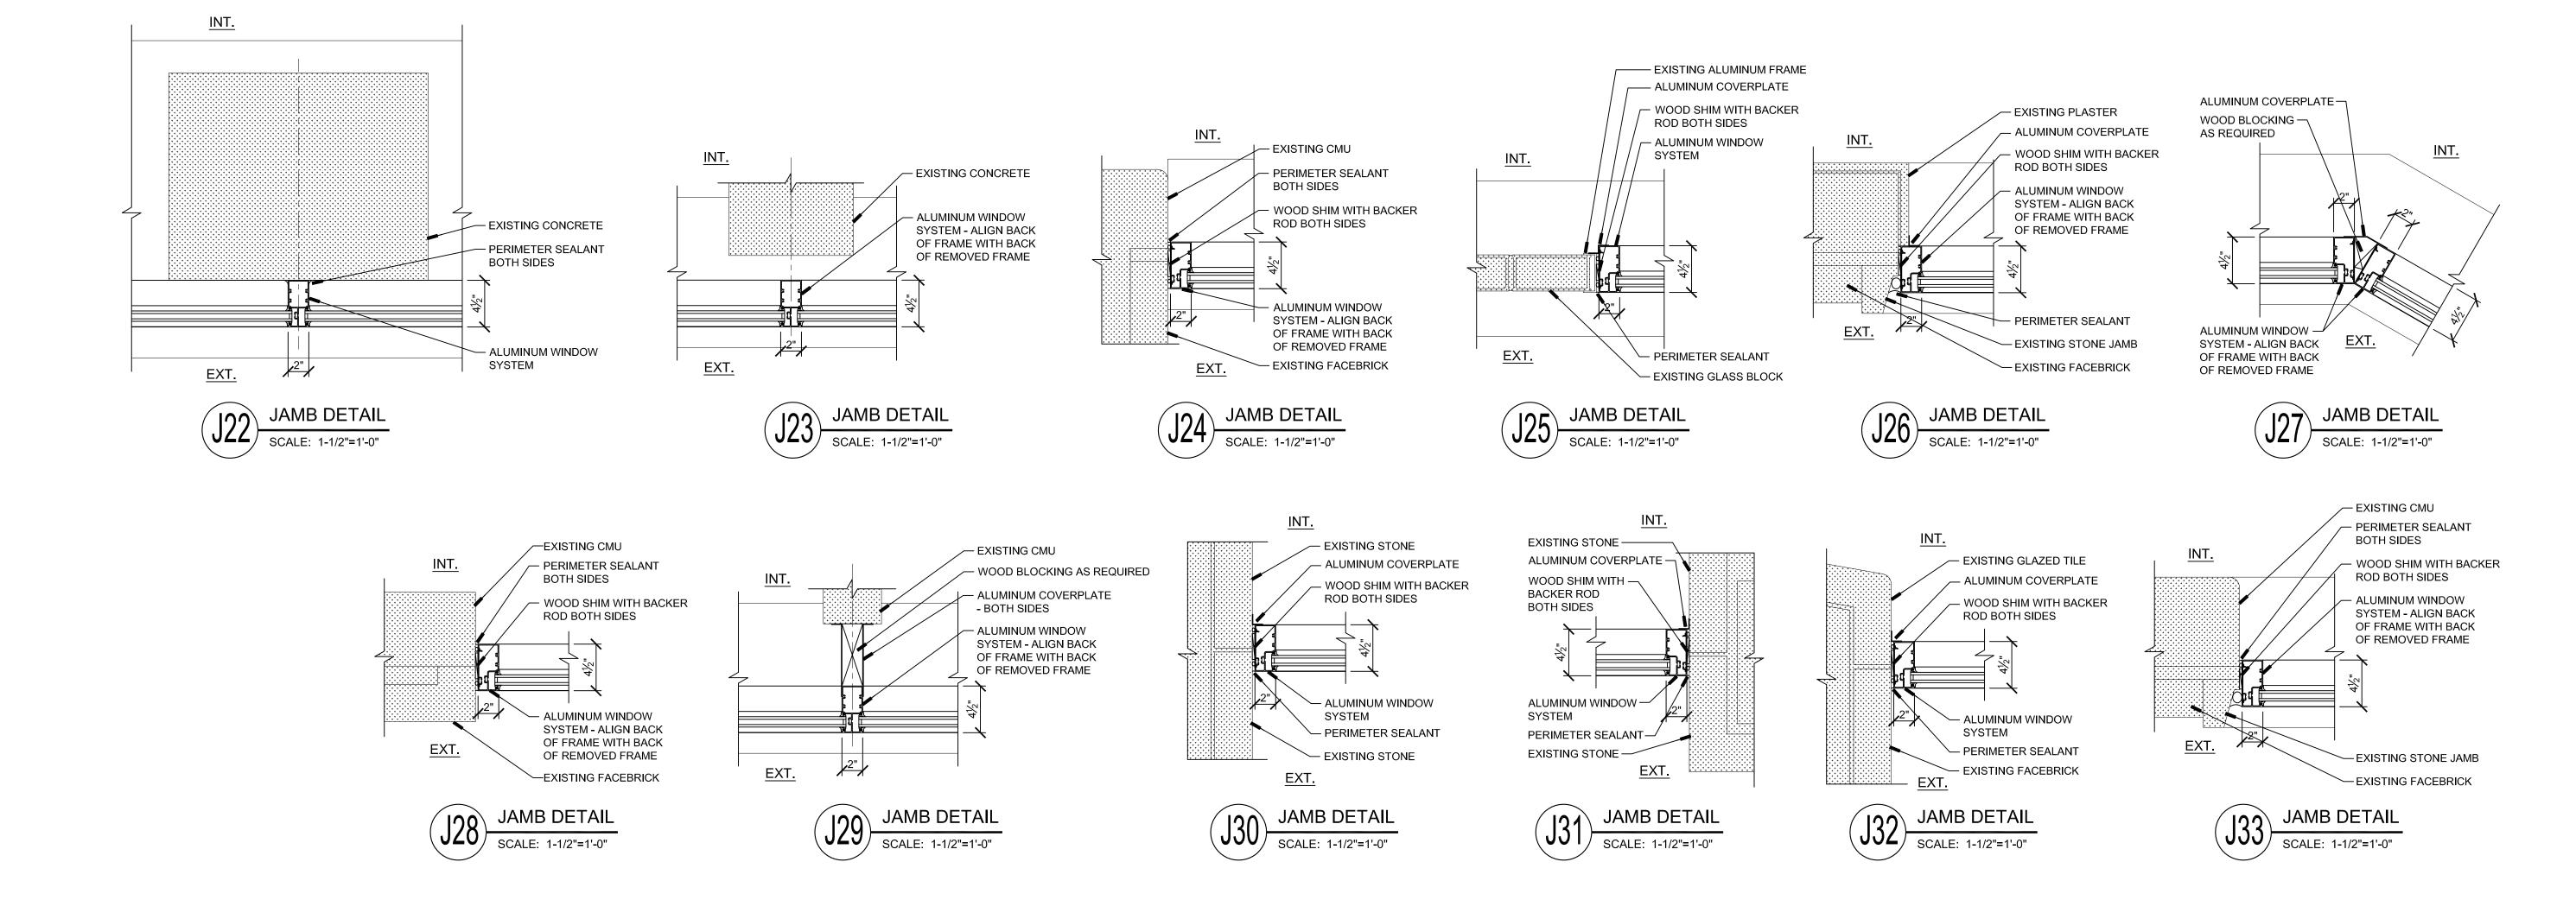

GENERAL NOTES

LOADING FOR ALL WINDOW TYPES.

2. SEE SHEET A109 FOR ADDITIONAL NOTES.

IF CLIP ANCHORS ARE USED, CONTRACTOR IS

4. DIMENSIONS SHOWN ARE TAKEN FROM EXISTING

LARGE ENOUGH TO COVER ANCHOR CLIPS.

REINFORCEMENT AS REQUIRED TO MEET STRUCTURAL

3. ANCHORING TO BE DETERMINED BY MANUFACTURER, BUT

INTERIOR JAMB TO EXISTING INTERIOR JAMB, AND FROM

EXISTING INTERIOR STOOL TO EXISTING INTERIOR HEAD.

RESPONSIBLE TO PROVIDE REQUIRED INTERIOR TRIM

1. CONTRACTOR IS RESPONSIBLE FOR ADDING STRUCTURAL 5. OUTSIDE FACE OF NEW FRAME TO LINE WITH OUTSIDE

FACE OF EXISTING FRAME UNLESS NOTED OTHERWISE.

7. PROVIDE AWNING TYPE WINDOWS WHERE DESIGNATED

8. CONTRACTOR TO PROVIDE INTERIOR METAL TRIM AT

FLOORS, WALLS AND CEILINGS AS REQUIRED TO COVER

ANY EXPOSED CONSTRUCTION WHETHER SHOWN ON

6. CONTRACTOR TO FIELD MEASURE ALL DOOR AND

WINDOW OPENINGS.

DETAILS OR NOT.

ON WINDOW TYPE ELEVATIONS.







SHEET NUMBER

A120

1. CONTRACTOR IS RESPONSIBLE FOR ADDING STRUCTURAL 5. OUTSIDE FACE OF NEW FRAME TO LINE WITH OUTSIDE

FACE OF EXISTING FRAME UNLESS NOTED OTHERWISE.

7. PROVIDE AWNING TYPE WINDOWS WHERE DESIGNATED

FLOORS, WALLS AND CEILINGS AS REQUIRED TO COVER

ANY EXPOSED CONSTRUCTION WHETHER SHOWN ON

8. CONTRACTOR TO PROVIDE INTERIOR METAL TRIM AT

6. CONTRACTOR TO FIELD MEASURE ALL DOOR AND

WINDOW OPENINGS.

DETAILS OR NOT.

ON WINDOW TYPE ELEVATIONS.

REINFORCEMENT AS REQUIRED TO MEET STRUCTURAL

3. ANCHORING TO BE DETERMINED BY MANUFACTURER, BUT

RESPONSIBLE TO PROVIDE REQUIRED INTERIOR TRIM

INTERIOR JAMB TO EXISTING INTERIOR JAMB, AND FROM EXISTING INTERIOR STOOL TO EXISTING INTERIOR HEAD.

LOADING FOR ALL WINDOW TYPES.

2. SEE SHEET A109 FOR ADDITIONAL NOTES

IF CLIP ANCHORS ARE USED, CONTRACTOR IS

4. DIMENSIONS SHOWN ARE TAKEN FROM EXISTING

LARGE ENOUGH TO COVER ANCHOR CLIPS.

